

DEPARTMENT OF REGULATORY AND ECONOMIC RESOURCES (RER) BOARD AND CODE ADMINISTRATION DIVISION

MIAMI-DADE COUNTY PRODUCT CONTROL SECTION

11805 SW 26 Street, Room 208 Miami, Florida 33175-2474 T (786) 315-2590 F (786) 315-2599

www.miamidade.gov/economy

NOTICE OF ACCEPTANCE (NOA)

York / Johnson Controls, Inc. 1499 East Philadelphia Street York, PA 17403

Scope:

This NOA is being issued under the applicable rules and regulations governing the use of construction materials. The documentation submitted has been reviewed and accepted by Miami-Dade County RER- Product Control Section to be used in Miami Dade County and other areas where allowed by the Authority Having Jurisdiction (AHJ).

This NOA shall not be valid after the expiration date stated below. The Miami-Dade County Product Control Section (In Miami Dade County) and/or the AHJ (in areas other than Miami Dade County) reserve the right to have this product or material tested for quality assurance purposes. If this product or material fails to perform in the accepted manner, the manufacturer will incur the expense of such testing and the AHJ may immediately revoke, modify, or suspend the use of such product or material within their jurisdiction. RER reserves the right to revoke this acceptance, if it is determined by Miami-Dade County Product Control Section that this product or material fails to meet the requirements of the applicable building code.

This product is approved as described herein, and has been designed to comply with the High Velocity Hurricane Zone of the Florida Building Code.

DESCRIPTION: "York Custom", "PACE", "Miller-Picking", Air Handling Units

APPROVAL DOCUMENT: Drawing No. 12-06, titled "York Custom (PACE & Miller-Picking) Air Handling Unit", sheets 1 through 19 of 19, and 7.1, 11.1, 11.2, prepared by Al-Farooq Corporation, dated December 10, 2012, Last revision #E dated June 09, 2016, signed and sealed by Javad Ahmad, P.E., bearing the Miami-Dade County Product Control Revision stamp with the Notice of Acceptance number and the expiration date by the Miami-Dade County Product Control Section.

MISSILE IMPACT RATING: Large and Small Missile Impact Resistant

LABELING: Each unit shall bear a permanent label with the manufacturer's name or logo, York, PA or Albany, MO and the following statement: "Miami-Dade County Product Control Approved", unless otherwise noted herein.

RENEWAL of this NOA shall be considered after a renewal application has been filed and there has been no change in the applicable building code negatively affecting the performance of this product.

TERMINATION of this NOA will occur after the expiration date or if there has been a revision or change in the materials, use, and/or manufacture of the product or process. Misuse of this NOA as an endorsement of any product, for sales, advertising or any other purposes shall automatically terminate this NOA. Failure to comply with any section of this NOA shall be cause for termination and removal of NOA.

ADVERTISEMENT: The NOA number preceded by the words Miami-Dade County, Florida, and followed by the expiration date may be displayed in advertising literature. If any portion of the NOA is displayed, then it shall be done in its entirety.

INSPECTION: A copy of this entire NOA shall be provided to the user by the manufacturer or its distributors and shall be available for inspection at the job site at the request of the Building Official.

1/e ly ff. fl. fl. 10 16

This NOA revises NOA #14-0903.01 and consists of this page 1, evidence submitted pages E-1 & E-2 as well as approval document mentioned above.

The submitted documentation was reviewed by Helmy A. Makar, P.E., M.S.

MIAMI-DADE COUNTY APPROYED NOA No. 16-0614.07 Expiration Date: 12/26/2018 Approval Date: 08/04/2016

Page 1

York / Johnson Controls, Inc.

NOTICE OF ACCEPTANCE: EVIDENCE SUBMITTED

EVIDENCE SUBMITTED UNDER PREVIOUS APPROVAL #12-1213.01 1.

A. **DRAWINGS**

Drawing No. 12-06, titled "Solution Air Handling Unit", sheets 1 through 19 of 19, 1. and 7.1. 11.1, 11.2, prepared by Al-Farooq Corporation, dated December 10, 2012, last revision #C dated October 01, 2013, signed and sealed by Javad Ahmad, P.E., on November 22, 2013.

В. **TESTS**

Test reports on 1) Uniform Static Air Pressure Test, Loading per TAS 202-94, 2) 1. Large Missile Impact Test per TAS 201-94, 3) Cyclic Wind Pressure Loading per TAS 203-94, along with marked-up drawings and installation diagram of Solution Air Handling Unit, prepared by Architectural Testing, Test Report No. C0445.01-801-18, dated 05/30/2013, signed and sealed by Vinu J. Abraham, P.E.

CALCULATIONS C.

Panel and fasteners analysis prepared by Al-Farooq Corporation, dated December 1. 13. 2012. signed and sealed by Javad Ahmad, P.E., on January 22, 2013.

OUALITY ASSURANCE D.

By Miami-Dade County Department of Regulatory and Economic Resources (RER). 1.

MATERIAL CERTIFICATIONS E.

Test report on foam, per ASTM D 1929 and ASTM E 84 of Solution Air Handler Unit, prepared by Architectural Testing, Test Report No. D3012.02-106-18, dated 11/20/2013, signed and sealed by Gary T. Hartman, P.E.

EVIDENCE SUBMITTED UNDER PREVIOUS APPROVAL #14-0903.01 2.

A. DRAWINGS

Drawing No. 12-06, titled "Solution Air Handling Unit", sheets 1 through 19 of 19, 1. and 7.1, 11.1, 11.2, prepared by Al-Farooq Corporation, dated December 10, 2012, Last revision #D dated August 22, 2014, signed and sealed by Javad Ahmad, P.E.

В. **TESTS**

Test reports on 1) Uniform Static Air Pressure Test, Loading per TAS 202-94, 2) 1. Large Missile Impact Test per TAS 201-94, 3) Cyclic Wind Pressure Loading per TAS 203-94, along with marked-up drawings and installation diagram of Solution Air Handling Unit, prepared by Architectural Testing, Test Report No. D9362.01-109-18, dated 08/19/2014, signed and sealed by Michael D. Stremmel, P.E.

> Helmy A. Makar, P.E., M.S. **Product Control Section Supervisor**

> > NOA No. 16-0614.07 Expiration Date: 12/26/2018 Approval Date: 08/04/2016

E - 1

York / Johnson Controls, Inc.

NOTICE OF ACCEPTANCE: EVIDENCE SUBMITTED

C. CALCULATIONS

1. Panel and fasteners analysis, 8 pages, prepared by Al-Farooq Corporation, dated August 22, 2014, signed and sealed by Javad Ahmad, P.E., on August 29, 2014.

D. QUALITY ASSURANCE

1. By Miami-Dade County Department of Regulatory and Economic Resources (RER).

E. MATERIAL CERTIFICATIONS

1. None.

F. OTHERS

1. Florida Building Code, 2014 Edition, compliance letter, dated August 26, 2014, prepared by Al-Farooq Corporation, signed and sealed by Javad Ahmad, P.E., on August 29, 2014.

3. NEW EVIDENCE SUBMITTED

A. DRAWINGS

1. Drawing No. 12-06, titled "York Custom (PACE & Miller-Picking) Air Handling Unit", sheets 1 through 19 of 19, and 7.1, 11.1, 11.2, prepared by Al-Farooq Corporation, dated December 10, 2012, Last revision #E dated June 09, 2016, signed and sealed by Javad Ahmad, P.E.

B. TESTS

1. None.

C. CALCULATIONS

1. None.

D. QUALITY ASSURANCE

1. By Miami-Dade County Department of Regulatory and Economic Resources (RER).

E. MATERIAL CERTIFICATIONS

1. None.

F. OTHERS


1. Florida Building Code, 2014 Edition, compliance letter, dated June 09, 2016, prepared by Al-Farooq Corporation, signed and sealed by Javad Ahmad, P.E., on June 10, 2016.

Helmy A. Makar, P.E., M.S. Product Control Section Supervisor

NOA No. 16-0614.07 Expiration Date:


Approval Date:

Housing Material Exterior Walls: 18 GA Steel or 0.08" Thk Alum Min Exterior Roof: 20 GA Steel Min Interior Walls & Roof: 22 GA Steel Min

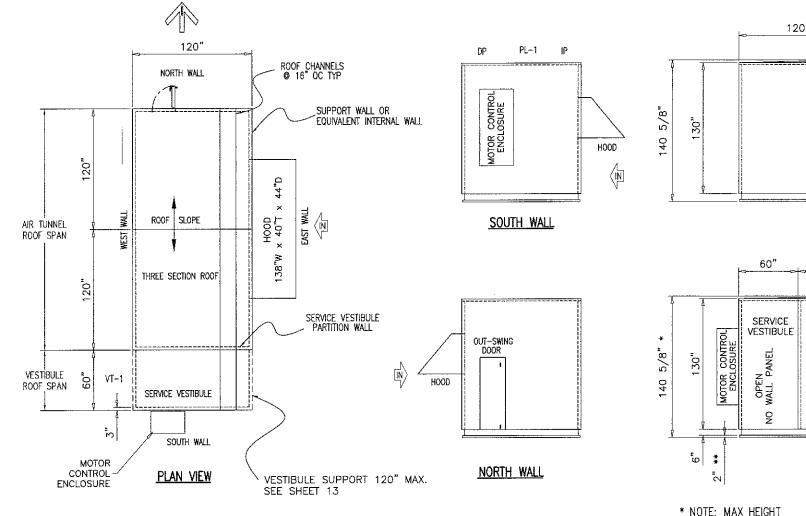

WALL CHANNELS 120" 120" AT 16" O.C. TYP. SERVICE VESTIBULE MOTOR TWO SECTION WALL

WEST WALL

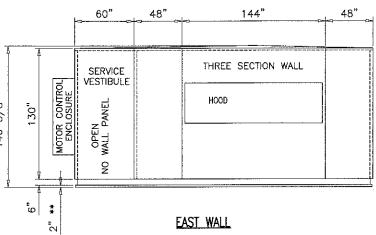


TO PEAK OF SLOPED ROOF ** NOTE: 2" CURB ANGLE

MAXIMUM DESIGN LOAD RATING = + 80.0 PSF - 80.0 PSF (FOR SIZES SHOWN ABOVE OR SMALLER)

GENERAL NOTES

- 1. THIS PRODUCT HAS BEEN DESIGNED AND TESTED TO COMPLY WITH THE REQUIREMENTS OF THE FLORIDA BUILDING CODE (FBC) FIFTH EDITION (2014) INCLUDING HIGH VELOCITY HURRICANE ZONE (HVHZ).
- 2. STRUCTURAL STEEL SHALL CONFORM TO ASTM DESIGNATION A-36 ND STEEL SHEET SHALL CONFORM TO ASTM DESIGNATION A-653. ALVANIZED WITH A COATING DESIGNATION OF G90. N. Fy = 48,380 PSI.
- 3. ALL CONCRETE SHALL HAVE A 28 DAY COMPRESSIVE STRENGTH OF 3000 PSI.
- 4. ELECTRICAL AND MECHANICAL DETAILS ARE NOT PART OF THIS APPROVAL
- 5. POLYURETHANE SHALL BE RIGID FOAM MIN. DENSITY #2 C.F.
- 6. MAX. FLAME SPREAD RATING = 0 AS PER ASTM E-84. SMOKE DEVELOPED INDEX = 135.
- SPONTANEOUS-IGNITION TEMPERATURE = 860°F.
- 7. ALL STEEL TO BE SHOP PRIMED BEFORE ASSEMBLY.
- 8. DISSIMILAR MATERIALS IN CONTACT WITH EACH OTHER SHALL BE PROTECTED IN ACCORDANCE WITH S.F.B.C. CHAPTER 30, SECTION 3004.4.
- 9. MIN. SOIL BEARING CAPACITY = 2500 PSF.
- 10. A LOAD DURATION INCREASE IS USED IN DESIGN OF ANCHORS INTO WOOD ONLY.
- 11. MATERIALS INCLUDING BUT NOT LIMITED TO STEEL/METAL SCREWS, THAT COME INTO CONTACT WITH OTHER DISSIMILAR MATERIALS SHALL MEET THE REQUIREMENTS OF THE FLORIDA BLDG, CODE.

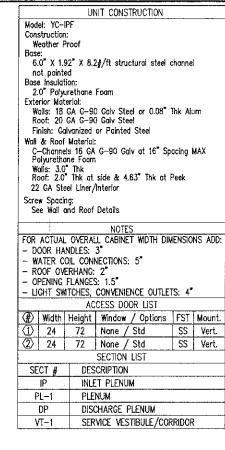

COOQ CORPORATION

8 & PRODUCT DEVELOPMENT

EET DRIVE, SUITE 220

RIDA 33173 (C.A.N. 3538)

34-8100 FAX. (305) 262-6978 (C.A.N. 3538) (. (305) 262-6978 NL-FAROC NGINEERS & 1 360 SUNSET I S YORK/JOHNSON CONTROLS I 1499 EAST PHILADELPHIA STRE YORK, PA. 17403 TEL. (717) 815-4218 FAX. (717) 81 Ą; Miller-Picking) 광 Custom

815-

-06YIC

desc NO Ch REV. I UPDAT SERIES

No. 70592

STATE OF

FLORIDA

ONAL

ENTITION

ONAL

ENTITY

ONAL

PRODUCT REVISED

Building Code

Miomi Dager

as complying with the Florida

Acceptance No 16-06/4.07
Expiration Date 12/26/2018

By He GH. Melon


date date 04.16.13 06.21.13 10.01.13 08.22.14 TO C B A O 1/8"=1-0" TARIO <u>ج</u> scale: | + 6

drawing no. 12-06

sheet 1 of 19


		۷.	ا د.	1
~	AND ADDRESS AND THE POSTURE AND ADDRESS AND ADDRESS AND TO EVOLUTION TO EVOLUTION AND ADDRESS AND THE POSTURE AND ADDRESS AND		A١	٩E
 	AIR HANDLING UNIT ASSEMBLY HAS BEEN TESTED AND ANALYZED FOR DESIGN PRESSURES NOT TO EXCEED THOSE SHOWN IN "ALLOWABLE DESIGN LOADS" TABLE FOR THE MAXIMUM SIZED PANEL DIMENSIONS AND FRAMING DISTANCE SPACING INDICATED ON		GΑ	۱L
	ACCOMAGE DESIGN COADS TABLE FOR THE MAXIMUM SIZED PARCE DIMENSIONS AND TOWNING DISTANCE STAGING INDICATED ON DRAWINGS.		MII	N
		~		


- 2. THE DETAILS AND SPECIFICATIONS SHOWN ON ALL SHEETS INDICATED REPRESENT THE PRODUCTS AND MATERIALS TESTED AND PROPOSED FOR IMPACT, CYCLIC, AND UNIFORM STATIC AIR PRESSURE TESTING IN ACCORDANCE WITH FLORIDA BUILDING CODE PROTOCOLS TAS 201, TAS 202, AND TAS 203 FOR LARGE MISSILE IMPACT. ADDITIONALLY THE PRODUCT WAS TESTED IN ACCORDANCE WITH ASTM E72 FOR COMPONENT SYSTEM RACKING AND ASTM E8 FOR TENSION TESTING OF THE MATERIAL COMPONENTS.
- 3, ATTACHMENT TO THE ROOF AND THE ROOF CURB TO PREVENT SLIDING AND OVERTURNING OF THE AIR HANDLING UNIT IS NOT PART OF THE SCOPE OF THIS PRODUCT APPROVAL. THESE ELEMENTS SHALL BE REVIEWED BY THE CORRESPONDING BUILDING DEPARTMENT. 4. IT SHALL BE THE RESPONSIBILITY OF THE PERMIT HOLDER TO VERIFY STRUCTURAL INTEGRITY OF THE ROOF/BUILDING STRUCTURE TO
- SUPPORT ALL LOADS (WIND AND STATIC) SUPERIMPOSED ON THE STRUCTURE BY THE AIR HANDLING UNIT. 5. INTERIOR MOUNTED MECHANICAL EQUIPMENT IS NOT PART OF THIS PRODUCT APPROVAL AND SHALL BE DESIGNED AND INSTALLED BY YORK/JOHNSON CONTROLS IN ACCORDANCE WITH ALL APPLICABLE CODES AND STANDARDS. INTERNAL SUPPORT OF THESE INTERIOR COMPONENTS IS ALSO OUTSIDE THE SCOPE OF THIS PRODUCT APPROVAL.
- 6. ALL HARDWARE & FASTENERS SHALL BE IN ACCORDANCE WITH THESE DRAWINGS AND SHALL NOT VARY UNLESS SPECIFICALLY STATED ON THE DRAWINGS.
- 7. ALL METAL THICKNESSES FOR PANELS, STRUCTURAL SUPPORT ELEMENTS AND OTHER COMPONENTS SHALL BE THE MINIMUM SPECIFIED GAGES DIMENSIONS INDICATED ON THE DRAWINGS.
- 8. ALL SHEET STEEL COMPONENTS SHALL BE MINIMUM 44 KSI SHEET STEEL AT THE SPECIFIED THICKNESS THAT CONFORMS TO ASTM A653, WITH G90U GALVANIZED FINISH

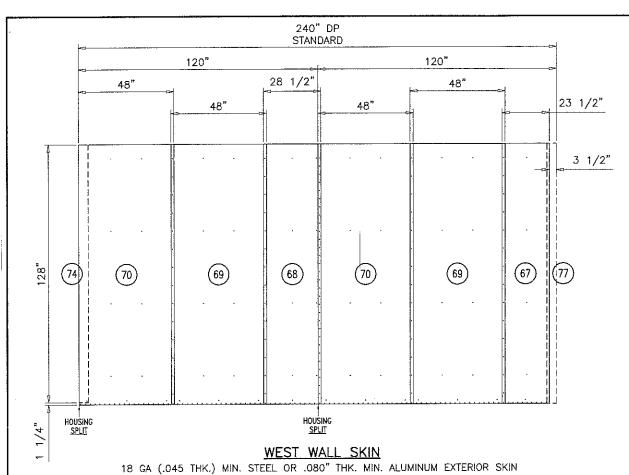

<u>GENERAL NOTES:</u>
1. SKINS HELD BACK .125 FROM ALL OPENINGS FRAMED BY 4 CHANNELS. 2. HEADER/FOOTER PIECES AT OPENINGS PLACED UNDER FULL LENGTH PIECES.

3. STANDARD EXTERIOR SKIN OVERLAP IS 1.50".

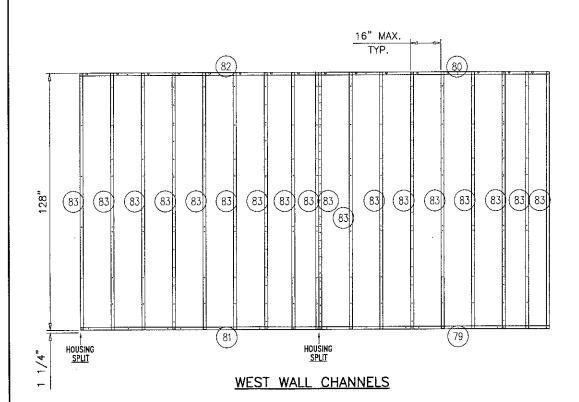

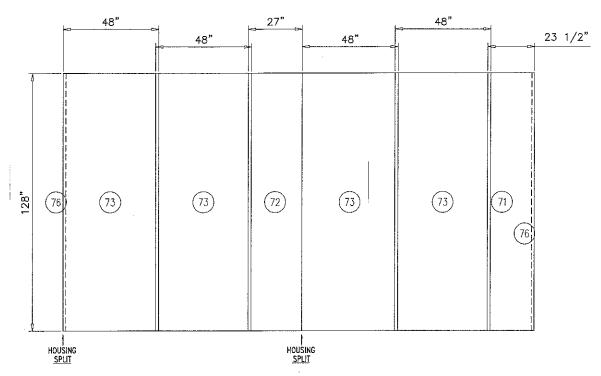

WEST WALL LINERS


22 GA (.028 THK.) MIN. G90 GALV. STEEL SKIN ON THE INTERIOR SIDE

GENERAL NOTES:
1. LINERS HELD BACK .125 FROM ALL OPENINGS FRAMED BY 4 CHANNELS.

2. HEADER/FOOTER PIECES AT OPENINGS PLACED UNDER FULL LENGTH PIECES.

3. STANDARD INTERIOR LINER OVERLAP IS 1.50".

LEVEL	ITEM	PART NO. *=Stocked	TOTAL QTY.	SORT FIELD	DESCRIPTION SHEET/REF.	QTY. ONE
I	66		1	WALL ASSEMBLY	WEST WALL: 240.00 X 128.00	1
	74		1	C: CORNER-CAP3	9.44W X 128.00L X AL,3105H14,.040	1
	77		1	C: CORNER-CAP3	9.44W X 129.25L X AL,3105H14,.040	1
	76		2	C: CORNER-LINER	2.65W X 127.94L X SHEET,GLV,G90,16GA	2
	67		1	C: EXT-SKIN-0	23.50W X 129.25L X AL,3105H14,.040	1
	68		1	C: EXT-SKIN-0	28.50W X 129.25L X AL,3105H14,.040	1
	69		2	C: EXT-SKIN-0	48.00W X 129.25L X AL,3105H14,.040	2
	70		2	C: EXT-SKIN-0	48.00W X 129.25L X AL,3105H14,.040	2
	71		1	C: INT-LINER-O	23.47W X 127.94L X SHEET,GLV,G90,22GA	1
	72		1	C: INT-LINER-O	26.97W X 127.94L X SHEET,GLV,G90,22GA	1
	73		4	C: INT-LINER-O	48.00W X 127.94L X SHEET,GLV,G90,22GA	4
	79		1	C: SC1.41X3.13-0	5.75W X 116.50L X CHANNEL,RF,16GA,GLV,5.67W_F	1
\prod	80		1	C: SC1.41X3.13-0	5.75W X 116.50L X CHANNEL,RF,16GA,GLV,5.67W_F	1
	81		1	C: SC1.41X3.13-0	5.75W X 120.00L X CHANNEL, RF, 16GA, GLV, 5.67W_F	1
	82		1	C: SC1,41X3.13-0	5.75W X 120.00L X CHANNEL, RF, 16GA, GLV, 5.67W_F	1
	83		18	C: SC1.50X2.94-0	5.74W X 127.75L X CHANNEL,RF,16GA,GLV,5.67W_F	18

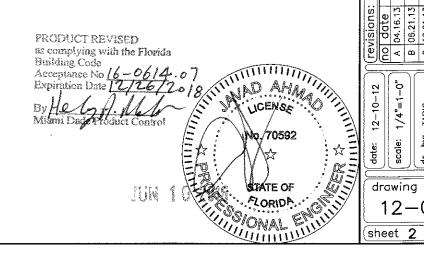



Q

by description

NO CHANGE THIS SHEET

REV. PER RER COMMENTS


NO CHANGE THIS SHEET


SERIES NAME REV.

瓷

늉

drawing no. 12 - 06sheet 2 of 19

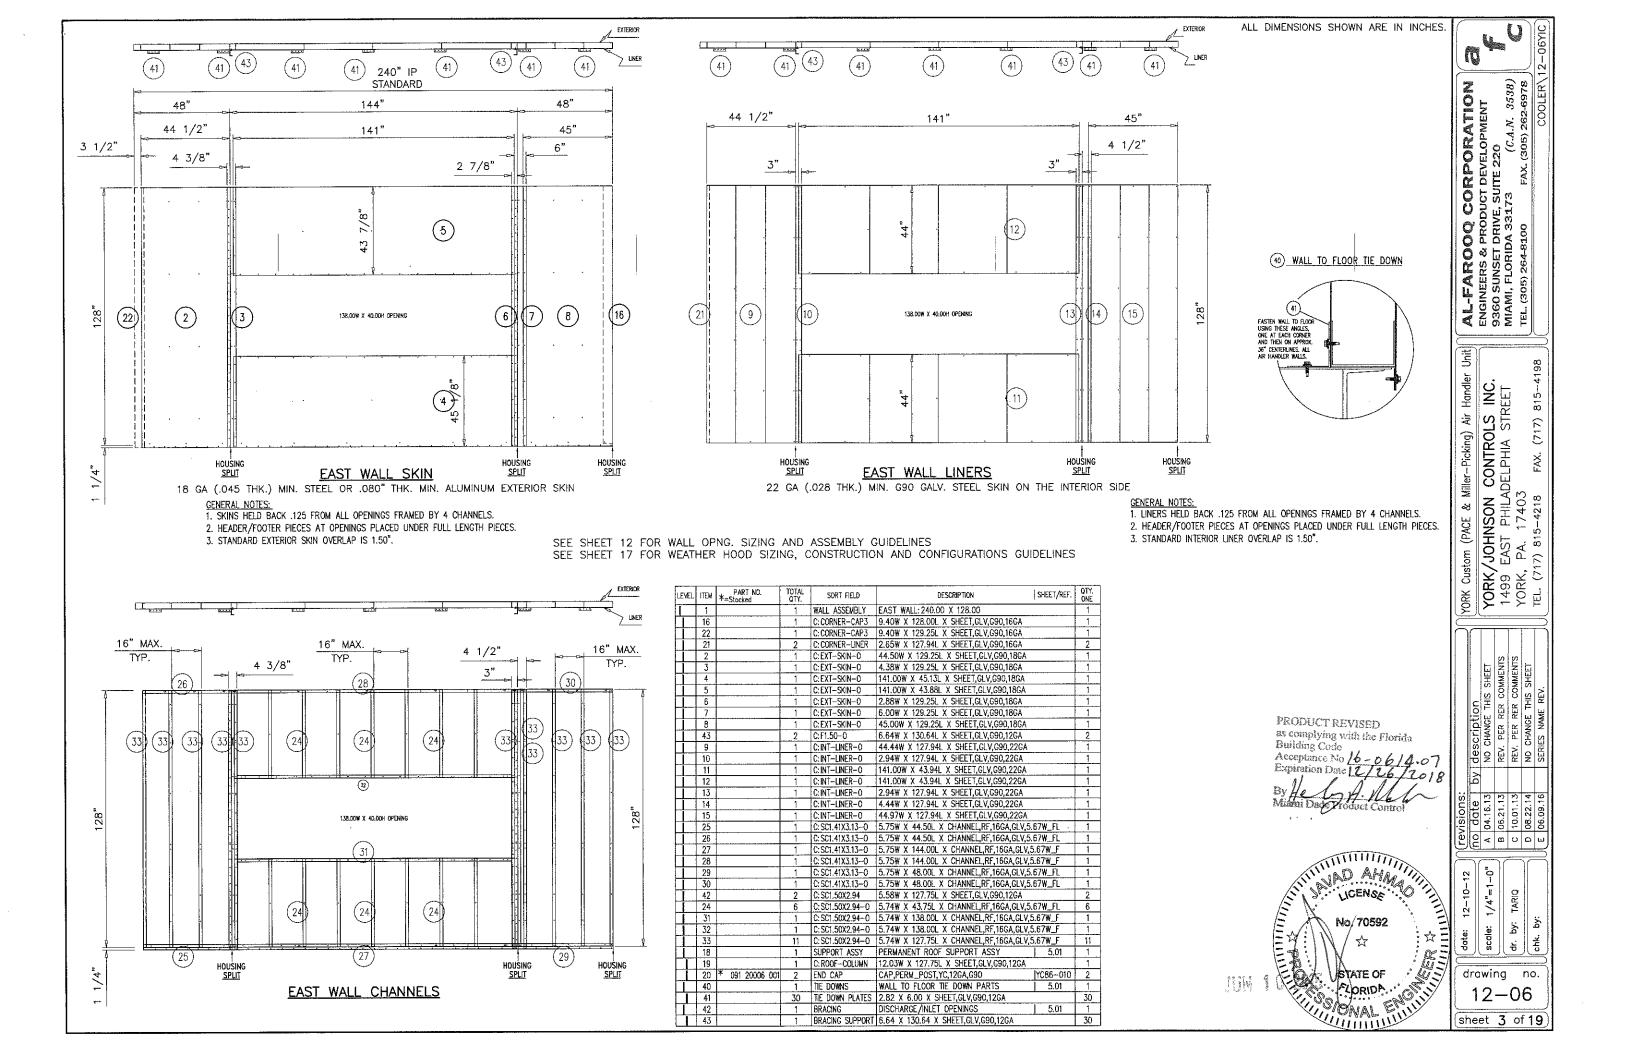


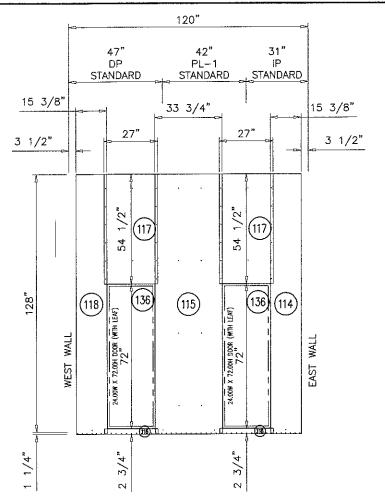


NORTH WALL SKIN

18 GA (.045 THK.) MIN. STEEL OR .080" THK. MIN. ALUMINUM EXTERIOR SKIN

- 1. SKINS HELD BACK .125 FROM ALL OPENINGS FRAMED BY 4 CHANNELS.
- 2. HEADER/FOOTER PIECES AT OPENINGS PLACED UNDER FULL LENGTH PIECES.
- 3. STANDARD EXTERIOR SKIN OVERLAP IS 1.50".

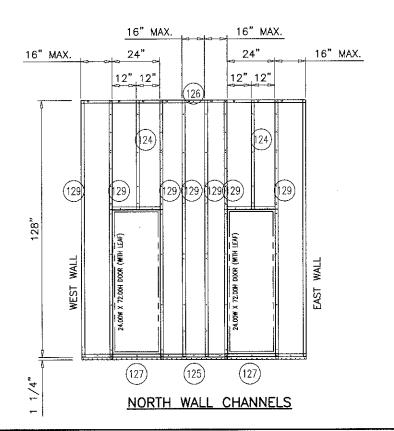

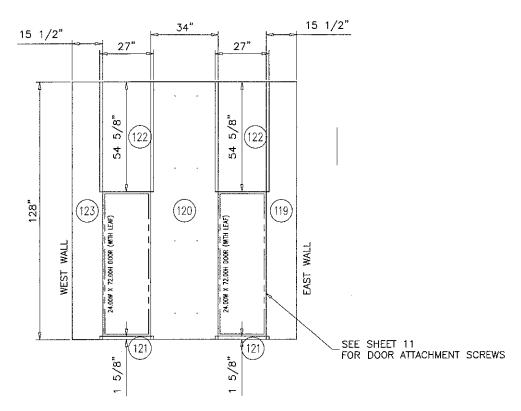


NORTH WALL LINERS

22 GA (.028 THK.) MIN. G90 GALV. STEEL SKIN ON THE INTERIOR SIDE

- 1. LINERS HELD BACK .125 FROM ALL OPENINGS FRAMED BY 4 CHANNELS.
 2. HEADER/FOOTER PIECES AT OPENINGS PLACED UNDER FULL LENGTH PIECES.
- 3. STANDARD INTERIOR LINER OVERLAP IS 1.50".

LEVEL	FTEM	PART NO. *=Stocked	TOTAL QTY.	SORT FIELD	DESCRIPTION SHEET/REF.	QTY. ONE
	113		1	WALL ASSEMBLY	NORTH WALL: 120.00 X 128.00	1
	114		1	C: EXT-SKIN-0	15.38W X 129.25L X AL,3105H14,.040	1
	115		1	C: EXT-SKIN-0	33.75W X 129.25L X AL,3105H14,.040	11
	116		2	C: EXT-SKIN-0	27.00W X 2.75L X AL,3105H14,.040	2
	117		2	C: EXT-SKIN-0	27.00W X 54.50L X AL,3105H14,.040	2
	118		1	C: EXT-SKIN-0	15.38W X 129.25L X AL,3105H14,.040	1
	119		1	C: INT-LINER-0	15.44W X 127.94L X SHEET,GLV,G90,22GA	11
	120		1	C: INT-LINER-0	33.94W X 127.94L X SHEET,GLV,G90,22GA	1
	121		2	C: INT-LINER-0	27.00W X 1.56L X SHEET,GLV,G90,22GA	2
	122		2	C: INT-LINER-0	27.00W X 54.56L X SHEET,GLV,G90,22GA	2
	123		1	C: INT-LINER-0	15.44W X 127.94L X SHEET,GLV,G90,22GA	1
	136		2	C: RAIN-LIP	2.57W X 25.75L X AL,3105H14,.040	2
	125		1	C: SC1.41X3.13-0	5.75W X 113.00L X CHANNEL,RF,16GA,GLV,5.67W_F	1
	126		1	C: SC1.41X3.13-0	5.75W X 113.00L X CHANNEL,RF,16GA,GLV,5.67W_F	1
	124		2	C: SC1.50X2.94-0	5.74W X 54.38L X CHANNEL,RF,16GA,GLV,5.67W_FL	2
	127		2	C: SC1.50X2.94-0	5.74W X 24.00L X CHANNEL,RF,16GA,GLV,5.67W_FL	2
	128		2	C: SC1.50X2.94-0	5.74W X 24.00L X CHANNEL,RF,16GA,GLV,5.67W_FL	2
	129		- 8	C: SC1.50X2.94-0	5.74W X 127.75L X CHANNEL,RF,16GA,GLV,5.67W_F	8

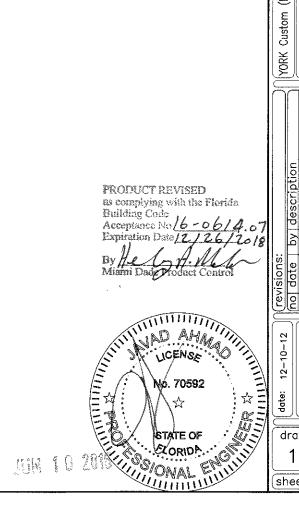

AL-FAROOQ CORPORATION
ENGINEERS & PRODUCT DEVELOPMENT
9360 SUNSET DRIVE, SUITE 220
MIAMI, FLORIDA 33173 (C.A.N. 3538)
TEL (305) 264-8100 FAX. (305) 262-6978 Jii. 815-4198 YORK Custom (PACE & Miller—Picking) Air Handler YORK/JOHNSON CONTROLS INC. 1499 EAST PHILADELPHIA STREET YORK, PA. 17403 TEL. (717) 815–4218 FAX. (717) 815–4 by description


NO CHANGE THIS S

REV. PER RER COM

REV. PER RER COM

NO CHANGE THIS S

SERIES NAME REV. 1/4"=1-0" <u>خ</u> scale: dr. by: chk. by drawing no. 12-06 sheet 4 of 19

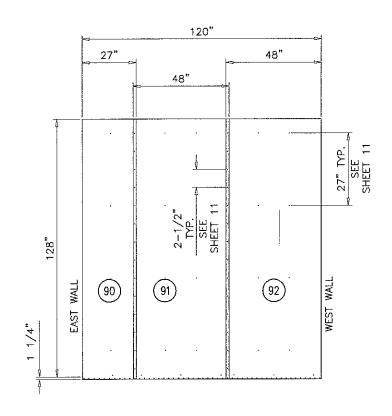


SOUTH WALL SKIN


18 GA (.045 THK.) MIN. STEEL OR .080" THK. MIN. ALUMINUM EXTERIOR SKIN

1. SKINS HELD BACK .125 FROM ALL OPENINGS FRAMED BY 4 CHANNELS.

2. HEADER/FOOTER PIECES AT OPENINGS PLACED UNDER FULL LENGTH PIECES.

3. STANDARD EXTERIOR SKIN OVERLAP IS 1.50".

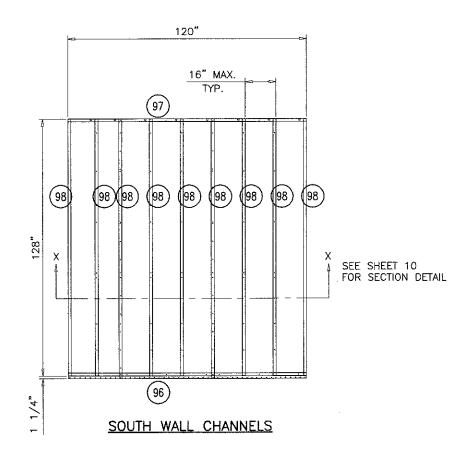

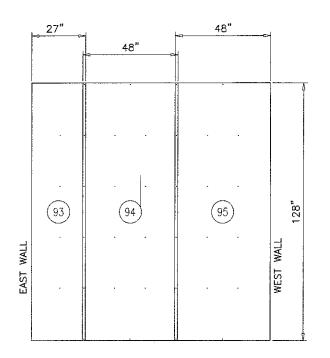

SOUTH WALL LINERS


22 GA (.028 THK.) MIN. G90 GALV. STEEL SKIN ON THE INTERIOR SIDE


1. LINERS HELD BACK .125 FROM ALL OPENINGS FRAMED BY 4 CHANNELS.

2. HEADER/FOOTER PIECES AT OPENINGS PLACED UNDER FULL LENGTH PIECES.

3. STANDARD INTERIOR LINER OVERLAP IS 1.50".

LEVEL	ITEM	PART NO. *=Stocked	TOTAL QTY.	SORT FIELD	DESCRIPTION SHEET/REF.	QTY. ONE
	89		1	WALL ASSEMBLY	SOUTH WALL: 120,00 X 128.00	1
	103	391 20002 002	29CF	OCR #574	FOAM MIX, PART A,B, & FREON	29CF
	90		1	C:EXT-SKIN-0	27.00W X 129.25L X SHEET,GLV,G90,18GA	1
	91		1	C: EXT-SKIN-0	48.00W X 129.25L X SHEET,GLV,G90,18GA	1
	92		1	C:EXT-SKIN-0	48.00W X 129.25L X SHEET,GLV,G90,18GA	1
	93		1	C:INT-LINER-0	26.94W X 127.94L X SHEET,GLV,G90,22GA	1
	94		1	C:INT-LINER-0	47.97W X 127.94L X SHEET,GLV,G90,22GA	1
	95		1	C:INT-LINER-0	47.97W X 127.94L X SHEET,GLV,G90,22GA	1
	96		1	C: SC1.41X3.13-0	5.75W X 120.00L X CHANNEL,RF,16GA,GLV,5.67W_F	1
	97		1	C: SC1.41X3.13-0	5.75W X 120.00L X CHANNEL,RF,16GA,GLV,5.67W_F	1
	98		9	C: SC1.50X2.94-0	5.74W X 127.75L X CHANNEL,RF,16GA,GLV,5.67W_F	9

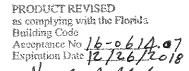

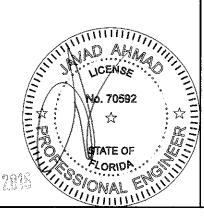


AL-FAROOQ CORPORATION
ENGINEERS & PRODUCT DEVELOPMENT
9360 SUNSET DRIVE, SUITE 220
MIAMI, FLORIDA 331.73 (C.A.N. 3538)
TEL (305) 264-8100 FAX. (305) 262-6978 YORK Custom (PACE & Miller-Picking) Air Handler Un YORK/JOHNSON CONTROLS INC. 1499 EAST PHILADELPHIA STREET YORK, PA. 17403
TEL. (717) 815–4218 FAX. (717) 815–4198 (717) 815-4198

U

1/4"=1-0" 12-10-12 <u>ب</u> date: + drawing no.

12 - 06

sheet 5 of 19

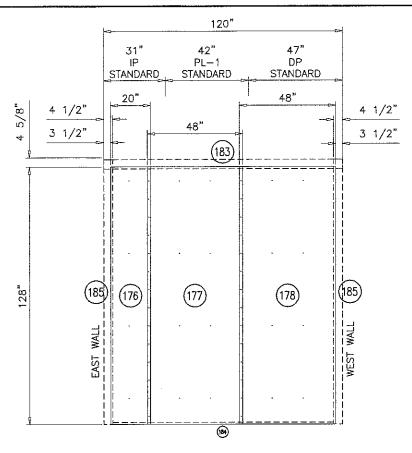


VESTIBULE/CORRIDOR WALL SKIN

18 GA (.045 THK.) MIN. STEEL OR .080" THK. MIN. ALUMINUM EXTERIOR SKIN

GENERAL NOTES:

- 1. SKINS HELD BACK .125 FROM ALL OPENINGS FRAMED BY 4 CHANNELS.
- 2. HEADER/FOOTER PIECES AT OPENINGS PLACED UNDER FULL LENGTH PIECES.
- 3. STANDARD EXTERIOR SKIN OVERLAP IS 1.50".

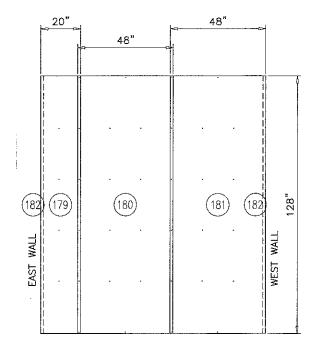

VESTIBULE/CORRIDOR WALL LINERS

22 GA (.028 THK.) MIN. G90 GALV. STEEL SKIN ON THE INTERIOR SIDE

- GENERAL NOTES:

 1. LINERS HELD BACK .125 FROM ALL OPENINGS FRAMED BY 4 CHANNELS.
- 2. HEADER/FOOTER PIECES AT OPENINGS PLACED UNDER FULL LENGTH PIECES.
- 3. STANDARD INTERIOR LINER OVERLAP IS 1.50".

			16" MAX. TYP.	
			ITP.	
7.			-(187)	
128"	188	(188) (188)	188 (188)	188 188
			(186)	

VESTIBULE/CORRIDOR WALL CHANNELS

LEVEL	ITEM	PART NO. *=Stocked	TOTAL QTY.	SORT FIELD	DESCRIPTION SHEET/REF.	QTY.
Ī	175		1	WALL ASSEMBLY	CORRIDOR WALL: 120.00 X 128.00	1
	184.		1	C: ATTACH-ANGLE	1.94W X 111.00L X SHEET,GLV,G90,20GA	. 1
	182		2	C: CORNER-LINER	2.65W X 127.94L X SHEET,GLV,G90,16GA	2
_	176		1	C: EXT-SKIN-0	20.00W X 128.00L X SHEET,GLV,G90,20GA	1
T	177		1	C:EXT-SKIN-0	48.00W X 128.00L X SHEET,GLV,G90,20GA	1
Ī	178		1	C: EXT-SKIN-0	48.00W X 128.00L X SHEET,GLV,G90,20GA	1
1	179		. 1	C:INT-LINER-0	19.94W X 127.94L X SHEET,GLV,G90,22GA	1
I	180		1	C:INT-LINER-0	47.97W X 127.94L X SHEET,GLV,G90,22GA	1
T	181		1	C:INT-LINER-0	47.97W X 127.94L X SHEET,GLV,G90,22GA	1
П	186		1	C: SC1.41X3.13-0	5.75W X 113.00L X CHANNEL,RF,16GA,GLV,5.67W_F	1
	187		1	C: SC1.41X3.13-0	5.75W X 113.00L X CHANNEL,RF,16GA,GLV,5.67W_F	1
1	188		9	C: SC1.50X2.94-0	5.74W X 127.75L X CHANNEL,RF,16GA,GLV,5.67W_F	9
T	185		2	C: SEAL-ANGLE	5.94W X 131.63L X SHEET,GLV,G90,20GA	2
I	183		1	C: SEAL-ANGLE-2	6.57W X 120.00L X SHEET,GLV,G90,20GA	1

No. 70592

STATE OF

LORIDA

LICENSE

STATE OF

LORIDA

PRODUCT REVISED

as complying with the Florida

AL-FAROOQ CORPORATION ENGINEERS & PRODUCT DEVELOPMENT 9360 SUNSET DRIVE, SUITE 220 MIAMI, FLORIDA 33173 (C.A.N. 3538) TEL. (305) 264-8100 FAX. (305) 262-6978 Unit YORK Custom (PACE & Miller-Picking) Air Handler Ur
YORK/JOHNSON CONTROLS INC.
1499 EAST PHILADELPHIA STREET
YORK, PA. 17403
TEL. (717) 815–4218 FAX. (717) 815–4198

(717) 815-4198

U

description

NO CHANGE THIS SHEET

REV. PER RER COMMENTS

REV. PER RER COMMENTS


NO CHANGE THIS SHEET

SERIES NAME REV. P C B D G


> scale: 1/4"=1-0" <u>;;</u> 유

12-10-12

drawing no. 12-06 sheet 6 of 19

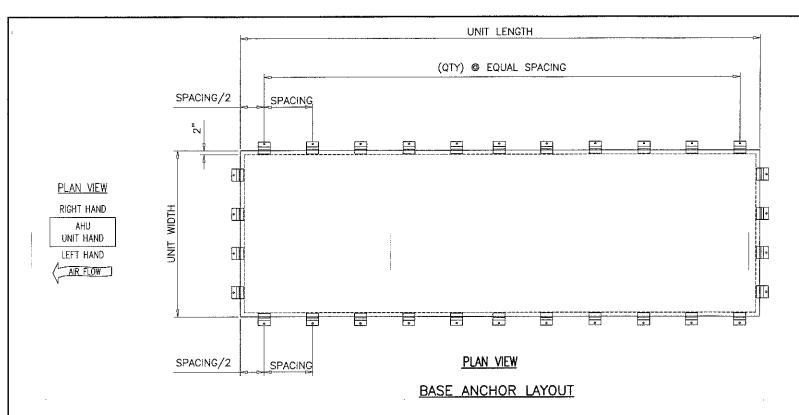

NOTE: ANCHOR SPACING WILL VARY BASED ON UNIT LENGTH BUT SHALL NOT EXCEED 16" O.C.

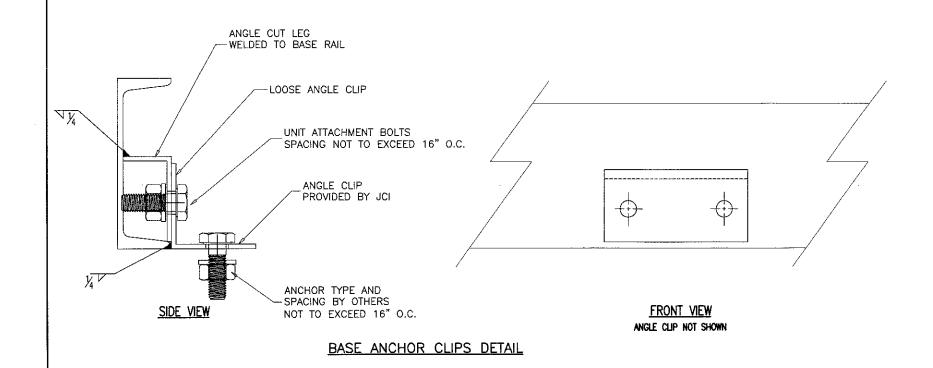

UNIT CONSTRUCTION

6" X 1.92" X 8.2#/ft structural steel channel 8" X 2.26" X 11.5#/ft structural steel channel 10" X 2.60" X 15.3#/ft structural steel channel 12" X 2.94" X 20.7#/ft structural steel channel painted w/ 6 to 8 mil DFT Champagne Epoxy. Base Insulation:


2" Polyurethane Foam Base Skin:

16 Ga Minimum.

Unit. Miller-Picking) Air Handler

Notes:

- 1. Unit base frame is bolted C-channel structural steel.
- 2. Air Handling Unit can vary in size however, spacing of the structural support elements such as the base frame, roof/wall panels, hardware spacing, hardware sizes, shall not exceed the dimensions or material gages indicated.
- 3. It shall be the responsibility of the permit holder to verify the strucutal integrity of the existing structure to support the loads superimposed by the Air Handling Unit.
- 4. Attachment to the concrete/steel structure to prevent sliding and overturning of the air handling unit is not part of the scope of this product approval. These elements shall be reviewed by the corresponding building department.

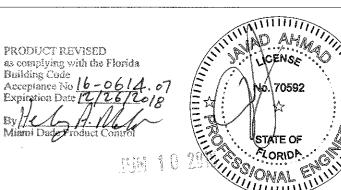

description
NO CHANGE THIS S
REV. PER RER CON
NO CHANGE THIS S
NO CHANGE THIS S
SERIES NAME REV. 1/4"=1-0" हें

(C.A.N. 3538) FAX. (305) 262-6978

AL-FAROOQ CORPORATION
ENGINEERS & PRODUCT DEVELOPMENT
9360 SUNSET DRIVE, SUITE 220
MIAMI, FLORIDA 33173 (C.A.N. 3538)
TEL. (305) 264-8100 FAX. (305) 262-6978

YORK/JOHNSON CONTROLS INC. 1499 EAST PHILADELPHIA STREET YORK, PA. 17403 TEL. (717) 815-4218 FAX. (717) 815-4


늉


drawing no. 12-06

sheet 7 of 19

INTERIOR BASE CHANNELS

- -INTERIOR BASE CHANNELS WILL BE FABRICATED FROM 10 GAUGE HR MATERIAL. WHEN THE MAXIMUM SPAN FOR FORMED CHANNEL IS EXCEEDED, STRUCTURAL CHANNEL WILL BE USED.)
- -IN GENERAL, THE INTERIOR BASE CHANNELS WILL SPAN THE SHORTEST DIRECTION (SEE EXAMPLES BELOW). SOME EXCEPTIONS TO THIS RULE ARE COIL DRAIN PANS, RECESSED FLOORS AND Evap-Pak SUMP SUPPORTS.

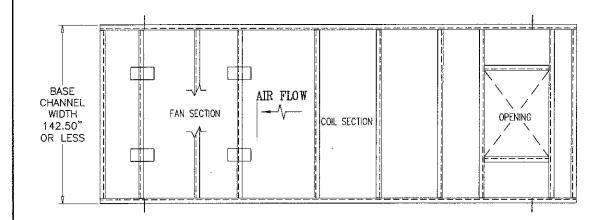


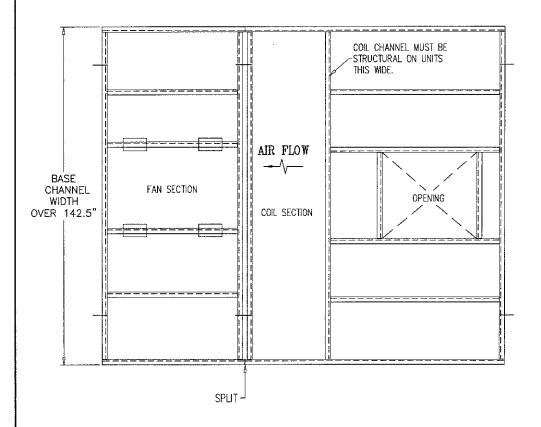


TYPICAL BASE CHANNEL LAYOUT


BASE SKIN LAYOUT

- -IN GENERAL THE BASE SKINS WILL BE SIZED WITH THEIR LONGEST DIMENSION PARALLEL TO THE SKIN SUPPORT CHANNEL.
- -ALL BASE SKIN SEAMS MUST BE SUPPORTED BY EITHER A FORMED OR STRUCTURAL CHANNEL,

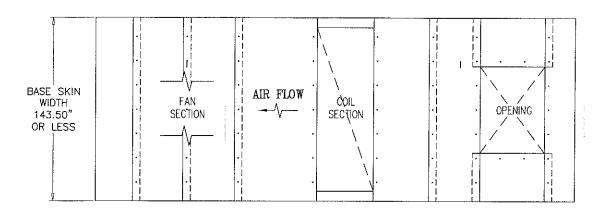

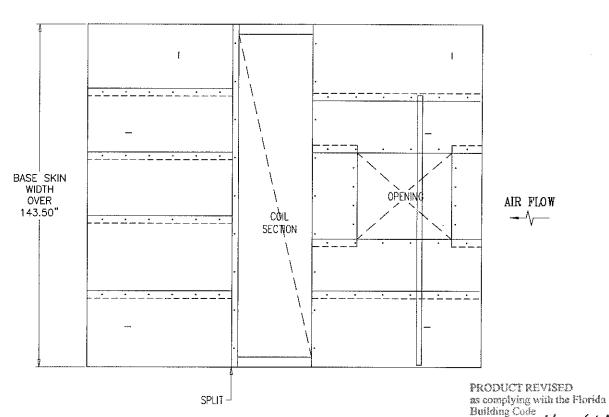

TYPICAL BASE SKIN LAYOUT

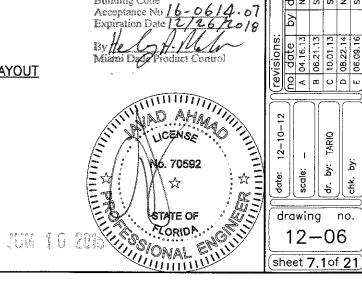

U

AL-FAROOQ CORPORATION
ENGINEERS & PRODUCT DEVELOPMENT
9360 SUNSET DRIVE, SUITE 220
MIAMI, FLORIDA 331.73 (C.A.N. 3538)
TEL. (305) 264-8100 FAX. (305) 262-6978

ni:

YORK Custom (PACE


815-4198


(717)

YORK Custom (PACE & Miller-Picking) Air Handler Ur
YORK/JOHNSON CONTROLS INC.
1499 EAST PHILADELPHIA STREET
YORK, PA. 17403
TEL. (717) 815–4218 FAX. (717) 815–4198


유 -

ALL DIMENSIONS SHOWN ARE IN INCHES.

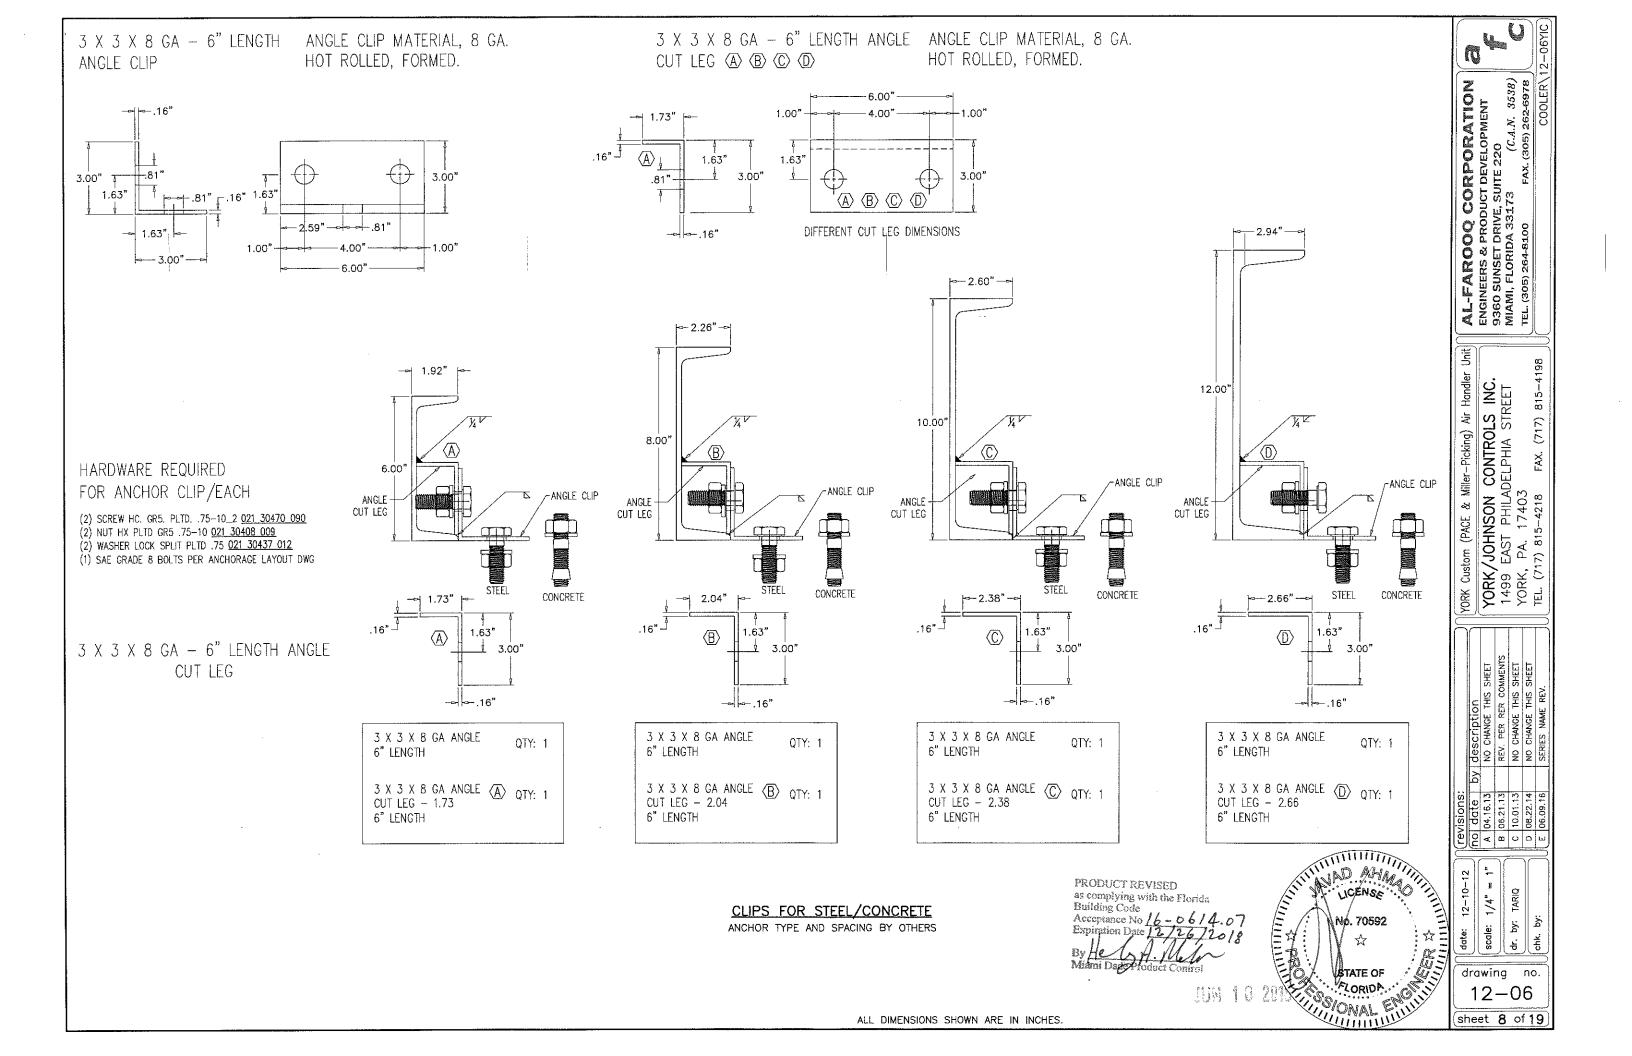

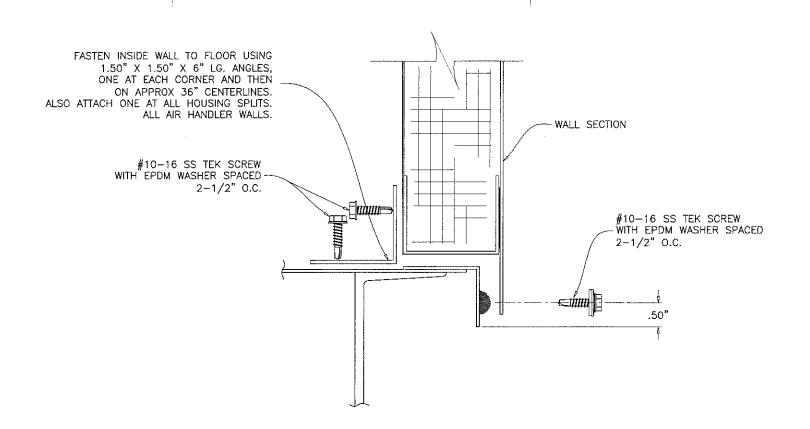

WALLS TO BASE WALL ATTACHMENT TO PERIMETER ANGLE

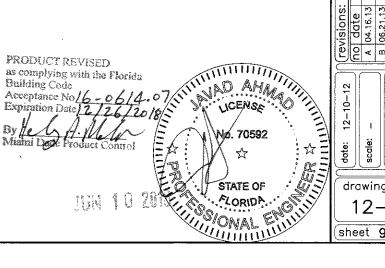

YORK Custom (PACE & Miller-Picking) Air Handler Un YORK/JOHNSON CONTROLS INC. 1499 EAST PHILADELPHIA STREET YORK, PA. 17403 TEL. (717) 815–4218 FAX. (717) 815–4198

(717) 815-4198

U


AL-FARGOQ CORPORATION
ENGINEERS & PRODUCT DEVELOPMENT
9360 SUNSET DRIVE, SUITE 220
MIAMI, FLORIDA 33173 (C.A.N. 3538)
TEL. (305) 264-8100 FAX. (305) 262-6978
COOLER\12


| revisions: | no date | A 04.16.13 | B 06.21.13 | C 10.01.13 | D 08.22.14 | E 06.09.16 |

瓷 유

drawing no. 12-06

sheet 9 of 19

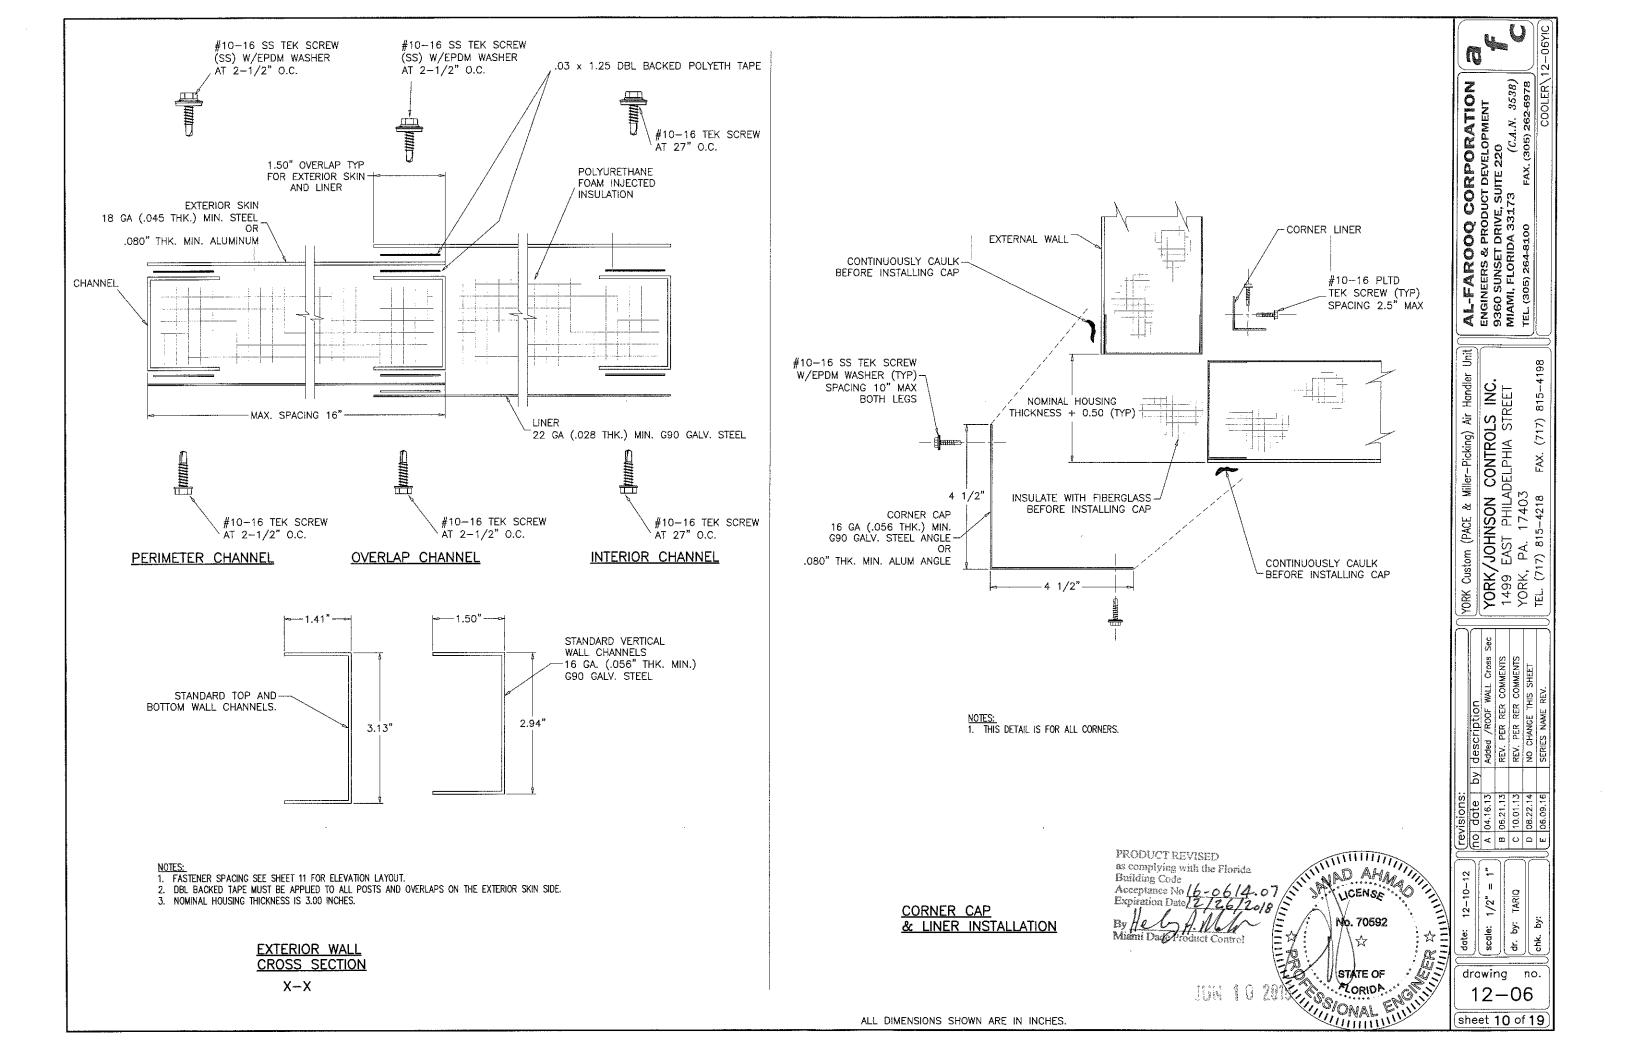

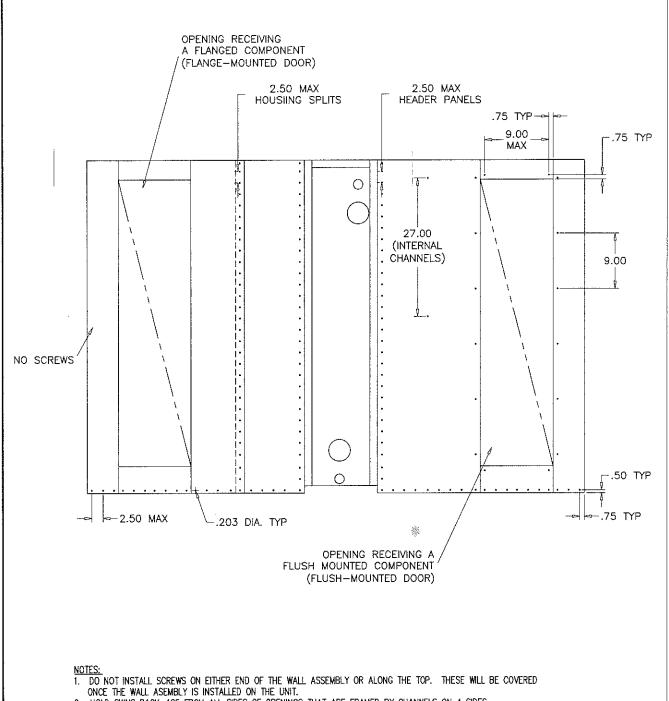

2. HOLD SKINS BACK .125 FROM ALL SIDES OF OPENINGS THAT ARE FRAMED BY CHANNELS ON 4 SIDES.

SCREW SPACING GUIDELINES FOR TYP. WALL AND ROOF EXTERIOR AND LINER SKINS

CONSTRUCTION:

THE CONSTRUCTION OF THE OUTDOOR ROOF IS SIMILAR TO THE EXTERIOR WALL CONSTRUCTION WITH THE EXCEPTION THAT THE POST IS A SLOPED CHANNEL AND WILL BE REFERRED TO AS A TRUSS. REFER TO THE EXTERNAL WALL SECTION FOR GENERAL CONSTRUCTION DETAILS AND MATERIAL STANDARDS. ACU-SHIELD SHOULD BE APPLIED AS A STANDARD. USE SAME GAGE EXTERIOR MATERIAL FOR THE ROOF THAT IS ON EXTERIOR OF THE WALL OF THE UNIT.


USE G90 GALV. FOR ALL ROOF EXTERIORS GETTING COATED WITH ACU-SHIELD.


GUIDELINES:

THE OUTDOOR ROOF WILL EITHER HAVE A SINGLE OR DOUBLE SLOPE WITH THE RISE BEING 1/4" PER FOOT (SEE DETAILS BELOW). SLOPE DIRECTION WILL BE INDICATED ON THE SUBMITTAL DRAWING. IF A SINGLE SLOPED ROOF IS REQUIRED, PITCH WILL TYPICALLY BE AWAY FROM THE ACCESS SIDE OF THE UNIT.

IF AN SQ IS GENERATED REQUIRING R14 MIN INSULATION, DETAILING WILL BE RESPONSIBLE FOR MAKING THE NECESSARY CHANGES TO THE PRODUCTION DRAWINGS TO MEET THIS REQUIREMENT AS SHOWN BELOW.

ROOF SECTIONS ARE ONLY TO BE SPLIT DOWN THE LENGTH OF THE SERVICE CORRIDOR WHEN A SHIPPING SPLIT IS REQUIRED. THE STANDARD DESIGN FOR DOUBLE SLOPED ROOFS WILL BE WITH THE RIDGE FALLING ON THE CENTER LINE OF THE UNIT. EXCEPTION TO STANDARD DESIGN: ALL UNITS WITH A SHIPPING SPLIT AT THE CORRIDOR WALL THAT REQUIRE A DOUBLE SLOPE ROOF MUST HAVE THE ROOF PEAK LOCATED AT THE CORRIDOR WALL. SEE DRAWINGS IN THIS SECTION FOR HOW THIS IS ACCOMPLISHED.

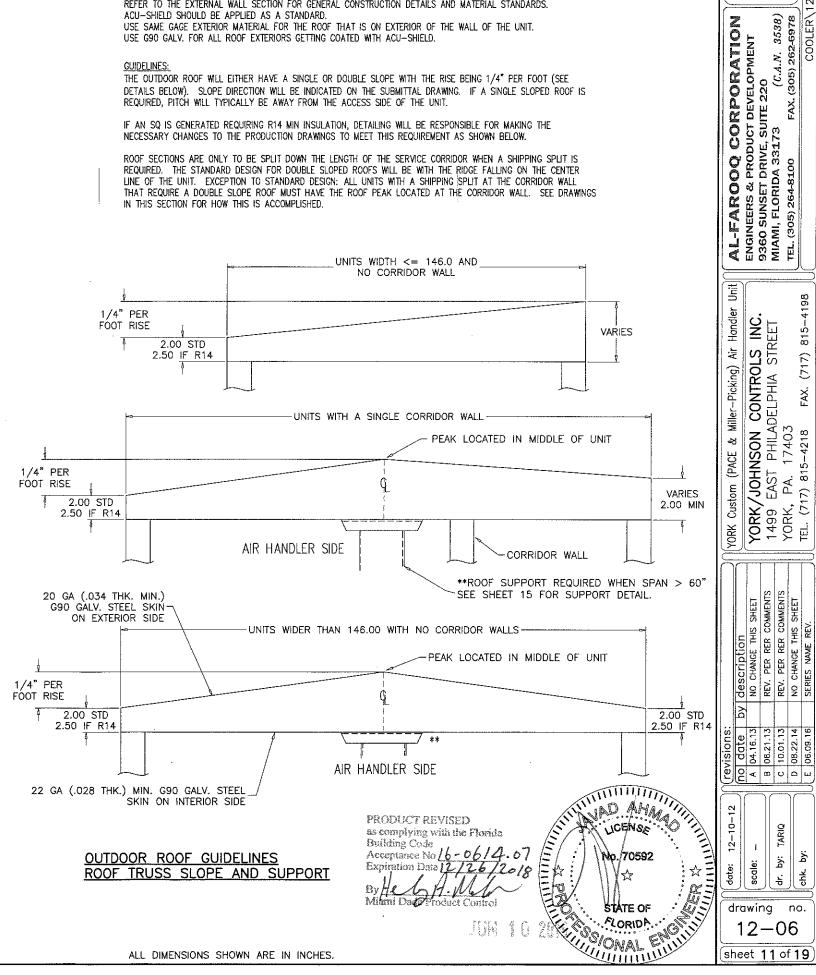

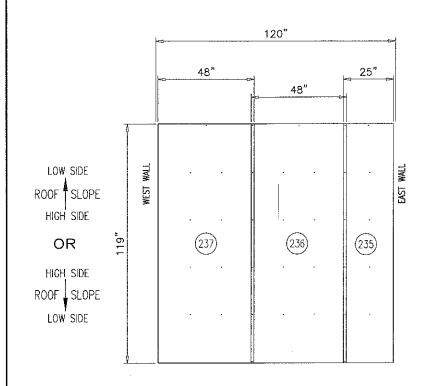


ROOF LINERS (VIEWED FROM LINER SIDE)

♦ AIR FLOW

GENERAL NOTES:


1. LINERS HELD BACK .125 FROM ALL OPENINGS FRAMED BY 4 CHANNELS.

2. HEADER/FOOTER PIECES AT OPENINGS PLACED UNDER FULL LENGTH PIECES. 3. STANDARD INTERIOR LINER OVERLAP IS 1.50".

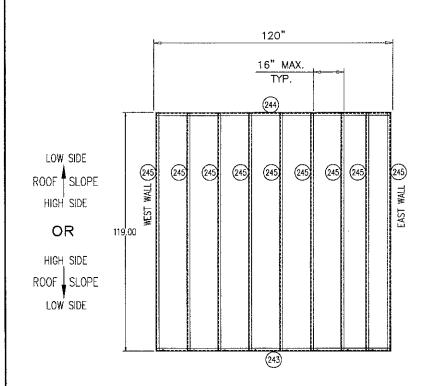

ROOF CHANNELS (VIEWED FROM LINER SIDE)

\$ AIR FLOW \$

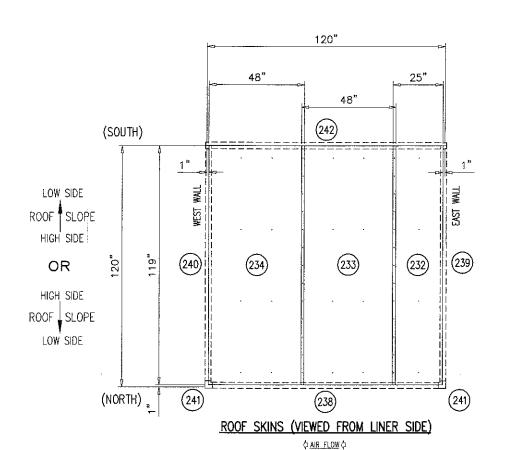


GENERAL NOTES:

1. SKINS HELD BACK .125 FROM ALL OPENINGS FRAMED BY 4 CHANNELS.

3. STANDARD EXTERIOR SKIN OVERLAP IS 1.50".

2. HEADER/FOOTER PIECES AT OPENINGS PLACED UNDER FULL LENGTH PIECES.

LEVEL	ITEM	PART NO. *=Stocked	TOTAL QTY.	SORT FIELD	DESCRIPTION	SHEET/REF.	QTY. ONE
	231		1	ROOF ASSEMBLY	ROOF ASSEMBLY: 120.00 X 120.00	4.03	1
Ī	252	391 20002 00	40CF	-10% OFFAL - OC	FORM MIX, PART A,B, & FREON		40CF
	242		1	C: ANGLED-COVER	3.25W X 121.50L X SHEET,GLV,G90,20GA		1
	232		1	C: EXT-SKIN-0	25.00W X 119.00L X SHEET,GLV,G90,20GA		1
	233		1	C: EXT-SKIN-0	48.00W X 119.00L X SHEET, GLV, G90, 20GA		1
	234		1	C: EXT-SKIN-0	48.00W X 119.00L X SHEET,GLV,G90,20GA		1
	240		1	C:HL3.75X6.25	10.70W X 117.00L X SHEET,GLV,G90,16GA		1
	235		1	C: INT-LINER-0	24.94W X 118,94L X SHEET,GLV,G90,22GA		1
	236		1.	C: INT-LINER-0	47.97W X 118.94L X SHEET,GLV,G90,22GA		1
	237		1	C: INT-LINER-0	47.97W X 118.94L X SHEET,GLV,G90,22GA		1
	239		1	C: LH6.25X3.75	10.70W X 117.00L X SHEET,GLV,G90,16GA		1
	238		1	C: ROOF-CAP	8.20W X 113.94L X SHEET, GLV, G90, 16GA		1
	241		2	C: ROOF-CNR-CAP	9.90W X 8.33L X SHEET,GLV,G90,16GA		2
	245		9	C: RT5.69X3.19	8.49W X 118.75L X SHEET, GLV, G90, 16GA		9
	243		1	C: SC1.50X3.38-0	6.18W X 118.00L X SHEET,GLV,G90,16GA		1
	244		1	C; SC1.50X5.88-0	8.68W X 118.00L X SHEET, GLV, G90, 16GA		1
	246	013 03317 05	9.90Z	CAULK	CAULK,AL_GRAY,SiKAFLEX_221		9.902
	249	013 01412 01	0.67GL	COATING	COATING, ACU-SHELD, WHITE		0.67G
	250	* 021 30531 01	222	SCREW	SCREW, TEK, 410SS, EPDM, 10-16_75		222
	251	* 021 30530 00	52	SCREW	SCREW,TEK,PLTD,10-1675		52
	253	* 091 20014 00	1 12	SUPER ANGLE	ANGLE, WALL_TO_ROOF, GLV	YC86-033	12
	247	028 14900 01	2677IN	TAPE	TAPE,POLYETH,DBL,.03W_1.25THK		2677
1	248	028 07417 01	243IN	TAPE	TAPE,BUTYL,1.25W13THK		243IN

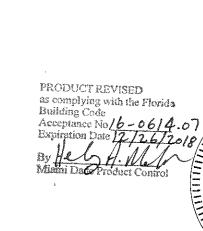

AL-FAROOQ CORPORATION
ENGINEERS & PRODUCT DEVELOPMENT
9360 SUNSET DRIVE, SUITE 220
MIAMI, FLORIDA 331.73 (C.A.N. 3538)
TEL. (305) 264-8100 FAX. (305) 262-6978
COOLER\12 YORK Custom (PACE & Miller-Picking) Air Handler Un YORK/JOHNSON CONTROLS INC. 1499 EAST PHILADELPHIA STREET YORK, PA. 17403
TEL. (717) 815–4218 FAX. (717) 815–4198

FAX. (717) 815-4198


<u>خ</u> ₽. drawing no.


10.01.13 08.22.14 06.09.16


ООШ

revisions: no date by description

12-06 (sheet **11.1**of**19**)

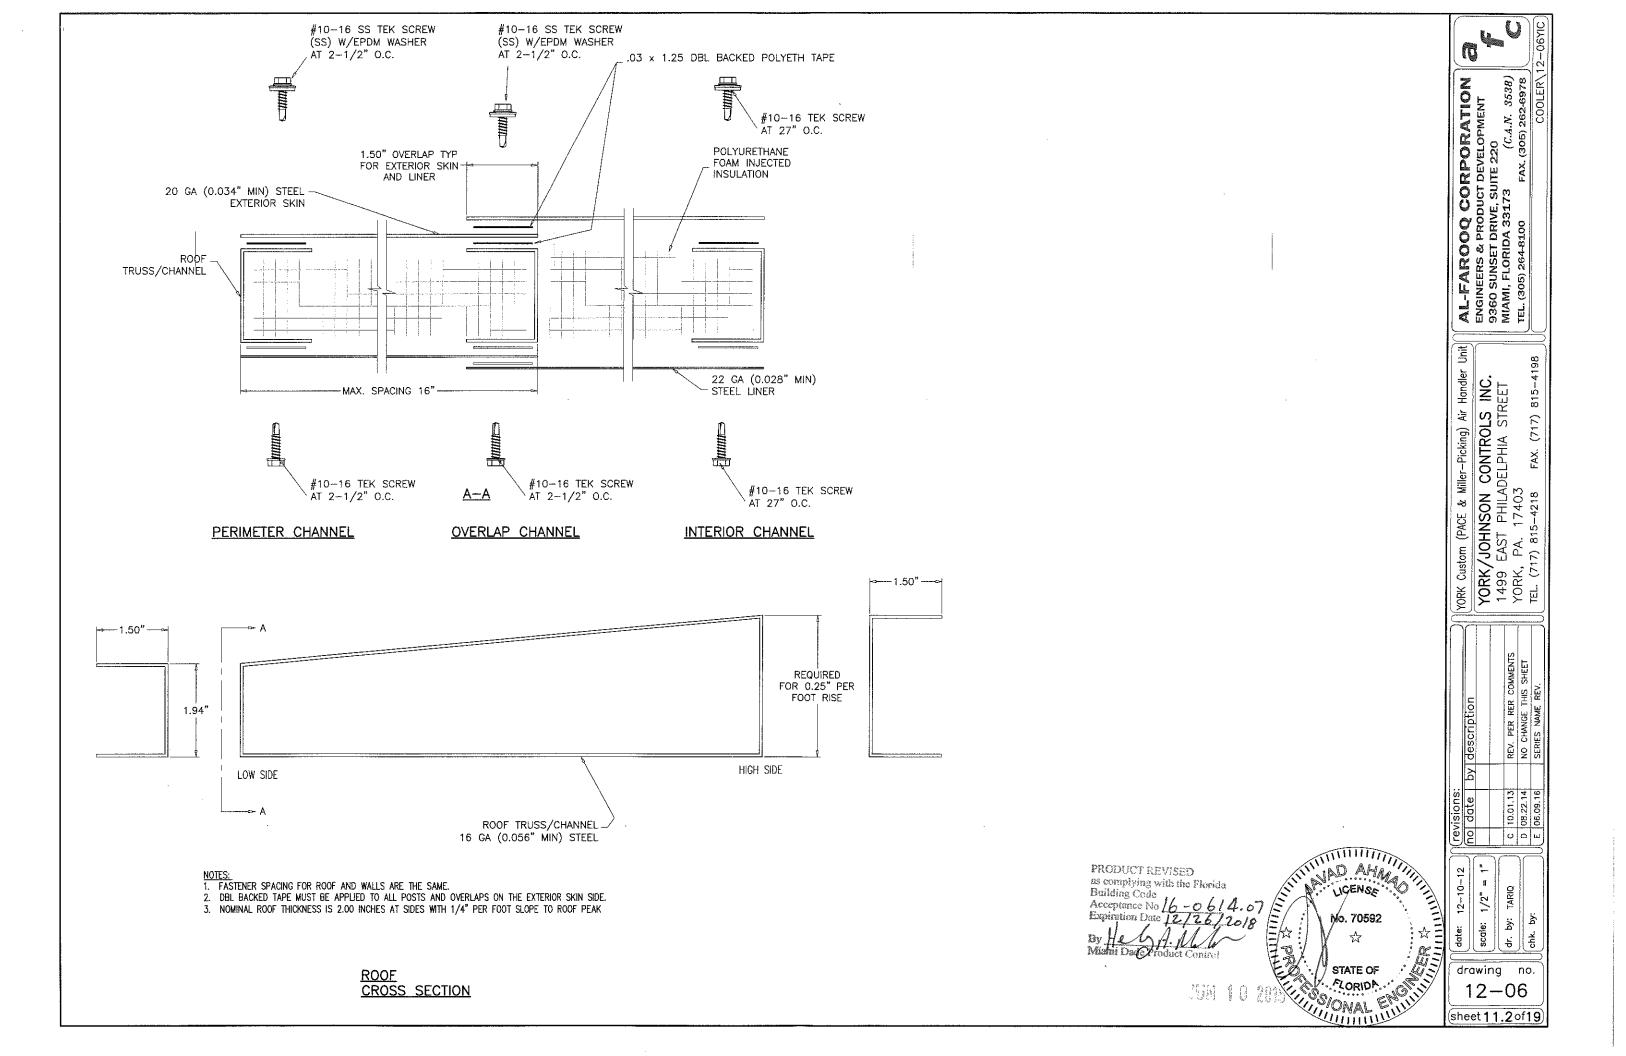


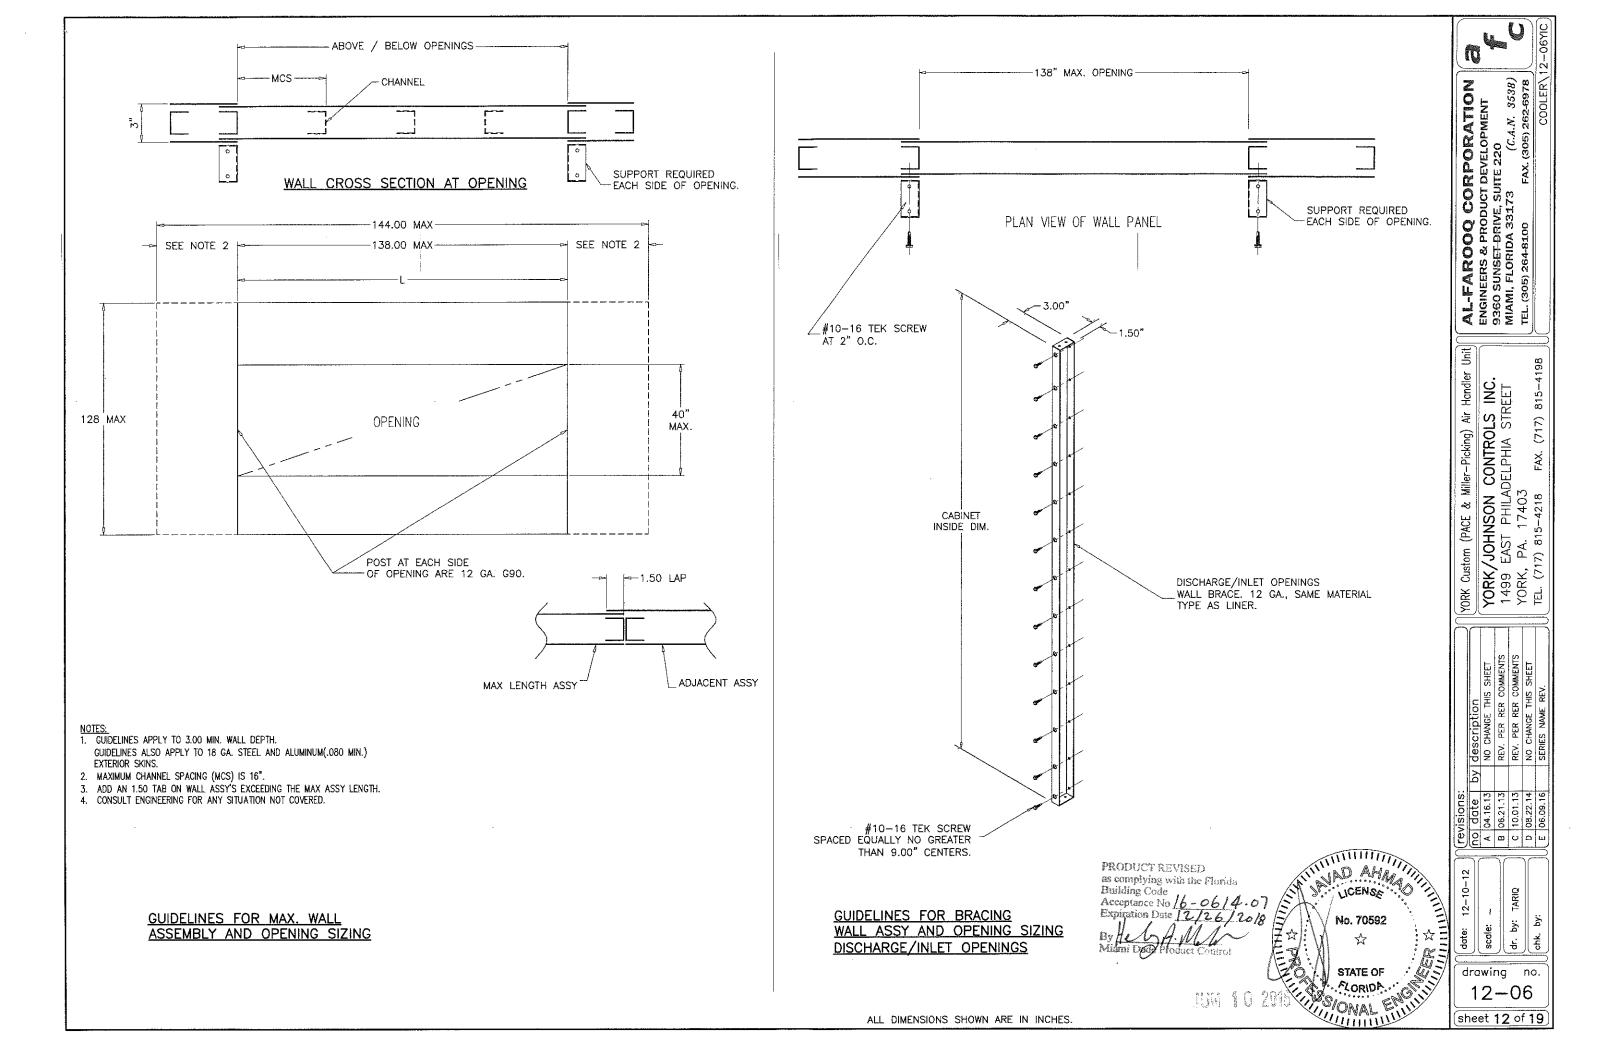

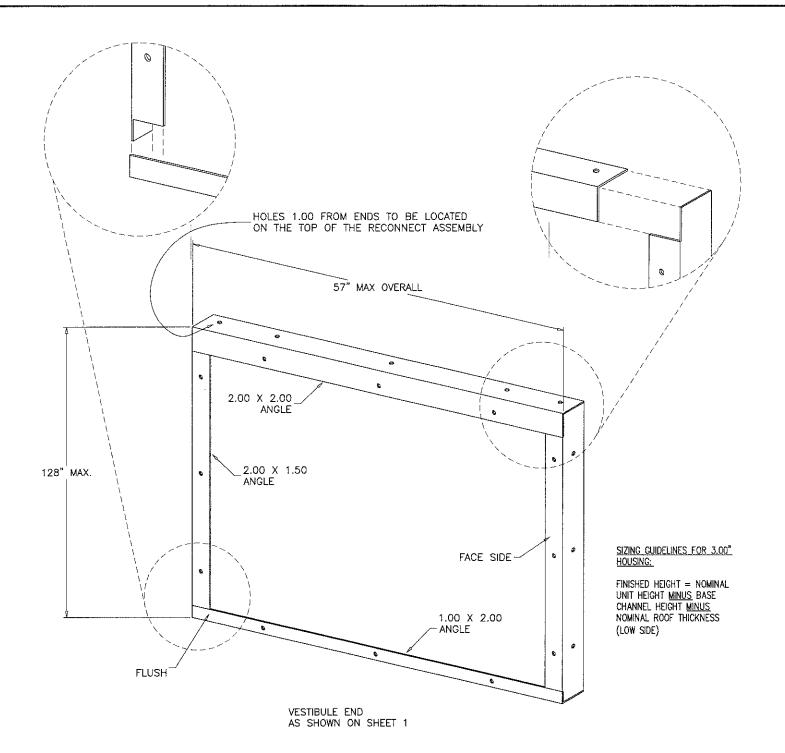

- 1. WELD INTO ASSY. WHERE APPLICABLE, ALL WELDS ARE CONTINUOUS 0.18" FILLET TYPE. DO NOT WELD ON THE FACE SIDE UNDER ANY CIRCUMSTANCES. IF SPLIT ASSY, BUTT WELD ON INSIDE OF ANGLE.
- 2. THERE MAY BE TIMES WHEN COMPONENTS MAY INTERFERE WITH THE INTERIOR SUPPORT(S). THIS WOULD TYPICALLY HAPPEN AT FAN DISCHARGE/INTAKE WALLS AND WHEN FILTERS ARE LOADED ACROSS A SPLIT. IN THESE SITUATIONS, THE DETAILER IS RESPONSIBLE FOR PROVIDING THE SHOP A LAYOUT SPECIFYING THE LOCATION OF THE SUPPORT(S).
- 3. THE STANDARD MATERIAL TYPE IS 12 GA G90. 4. PART LENGTH = FINISHED ASSY HEIGHT - 0.25"

INTERNAL RECONNECT ASSEMBLY FOR AIRWAY WIDTHS AND CORRIDOR UNIT LENGTHS

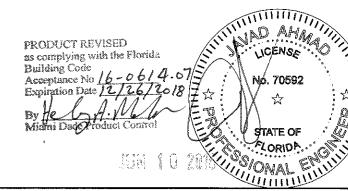

STATE OF

YORK Custom (PACE & Miller-Picking) Air Handler Un YORK/JOHNSON CONTROLS INC. 1499 EAST PHILADELPHIA STREET YORK, PA. 17403 TEL. (717) 815–4218 FAX. (717) 815–4198 12-10-12 TARIQ Ę. Š

drawing no.

12 - 06


sheet **13** of **19**

AL-FAROOQ CORPORATION
ENGINEERS & PRODUCT DEVELOPMENT
9360 SUNSET DRIVE, SUITE 220
MIAMI, FLORIDA 33173 (C.A.N. 3538)
TEL. (305) 264-8100 FAX. (305) 262-6978

Unit

(717) 815--4198

ALL DIMENSIONS SHOWN ARE IN INCHES.

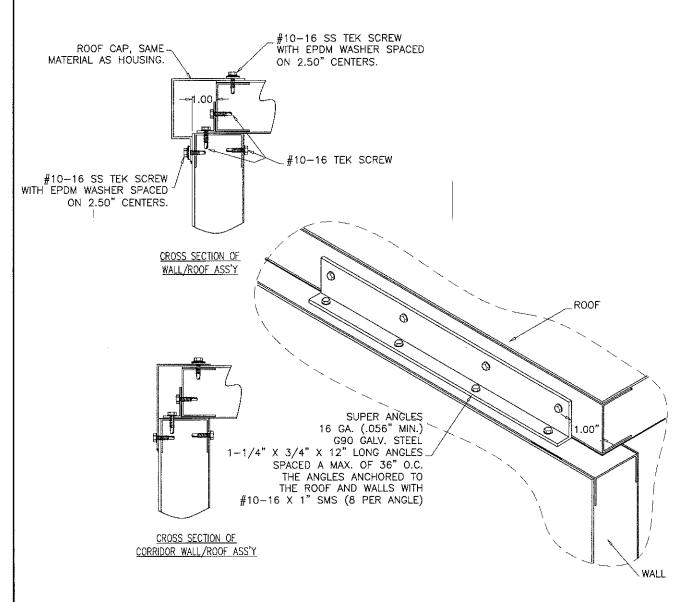





- NOTES:

 1. THE PURPOSE OF THE ANGLE IS TWO-FOLD. TO LIMIT LATERAL MOVEMENT OF THE WALL WHEN UNDER PRESSURE AND TO MAKE THE FIT OF THE ROOF LINER TO THE WALL LINER AS TIGHT AS REASONABLY POSSIBLE.
- 2. ROOF SIDES REQUIRE ANGLES ON 36" MAX. CENTERS.
- 3. ANGLES ARE REQUIRED AT EVERY COIL PANEL, HOUSING SPLIT(1" FROM SPLIT ON EACH SIDE OF SPLIT), AND 6" FILTER DOOR AS SHOWN ABOVE.


WALL TO ROOF ATTACHMENT GUIDELINES

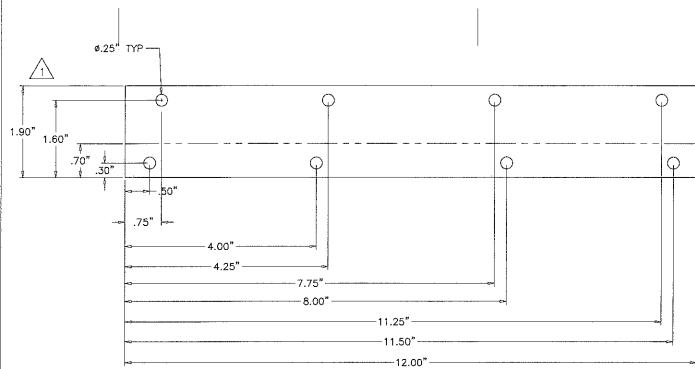

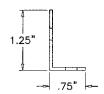

WALL TO ROOF ATTACHMENT ANGLE

PRODUCT REVISED as complying with the Florida Building Code Acceptance No 16 Expiration Date 12/26

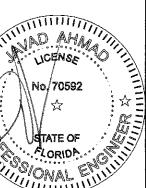

revisions:
no date
A 04.16.13
B 06.21.13
C 10.01.13
D 08.22.14
E 06.09.16 12-10-12 by: ₽ | ₽ ¥ drawing no.

 AL-FAROOQ CORPORATION

 ENGINEERS & PRODUCT DEVELOPMENT

 9360 SUNSET DRIVE, SUITE 220

 MIAMI, FLORIDA 33173
 (C.A.N. 3538)

 TEL. (305) 264-8100
 FAX. (305) 262-6978

& Miller-Picking) Air Handler

YORK Custom (PACE

815-4198


YORK/JOHNSON CONTROLS INC. 1499 EAST PHILADELPHIA STREET YORK, PA. 17403 TEL. (717) 815-4218 FAX. (717) 815-4


12-06

sheet 14 of 19

description
NO CHANGE THIS S
NO CHANGE THIS S
REV. PER RER COM
NO CHANGE THIS SI
SERIES NAME REV.

ALL DIMENSIONS SHOWN ARE IN INCHES

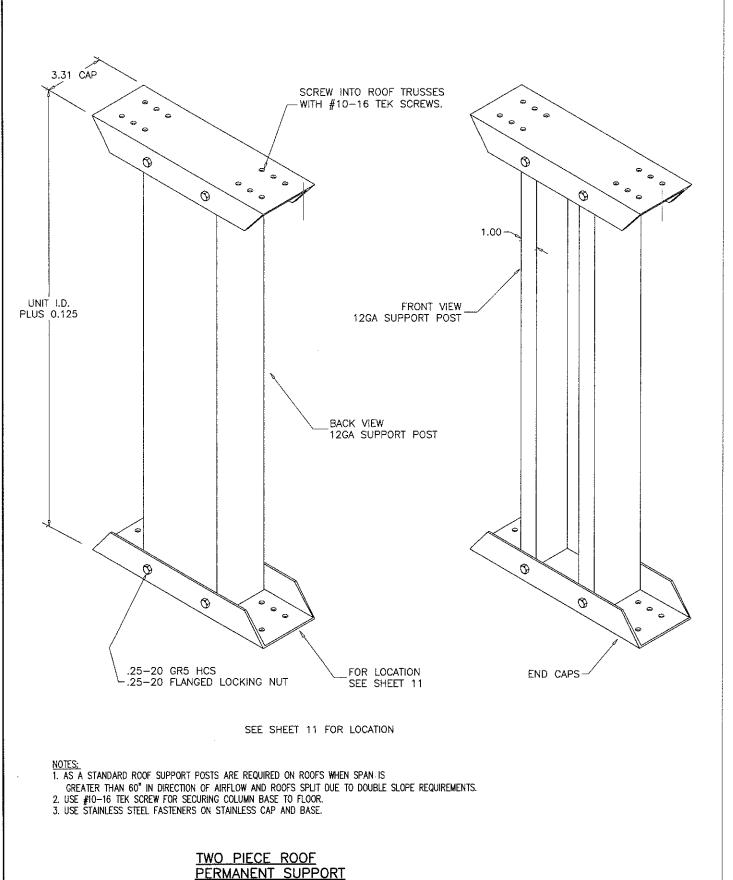


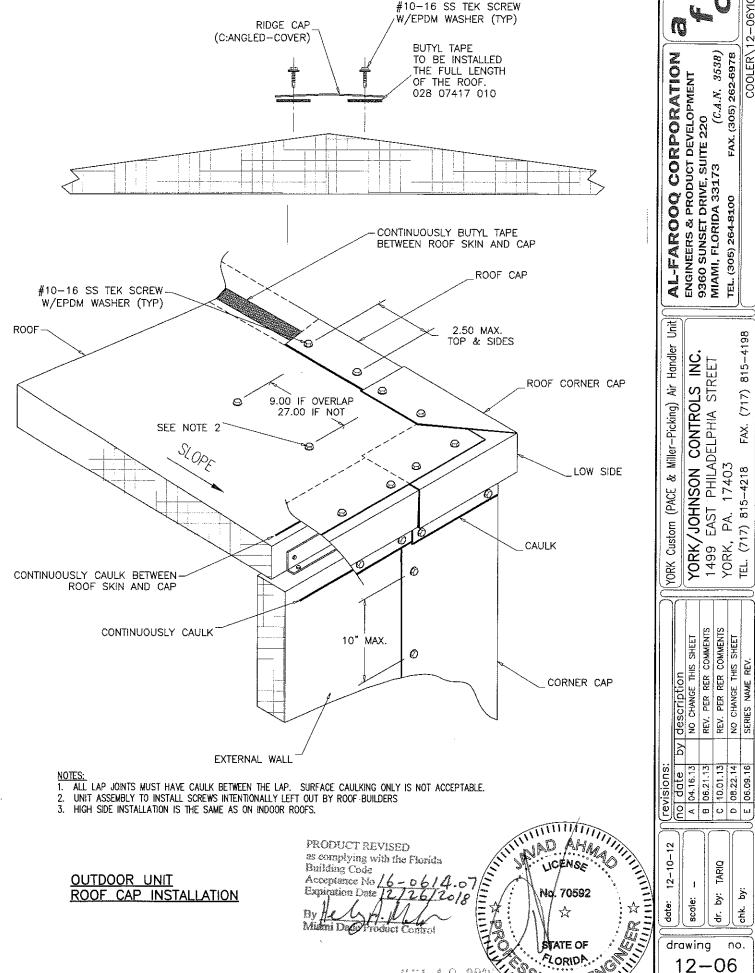

ALL DIMENSIONS SHOWN ARE IN INCHES.


815-4198

sheet **15** of **19**

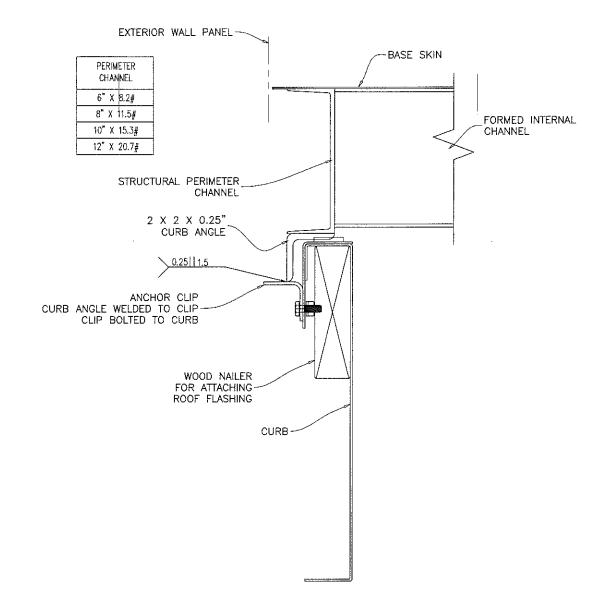


ROOF CURB HOLD DOWN DETAIL

SHALL BE DESIGNED FOR EACH SITE SPECIFIC BY A FLORIDA P.E. AND REVIEWED BY THE CORRESPONDING BUILDING DEPARTMENT.

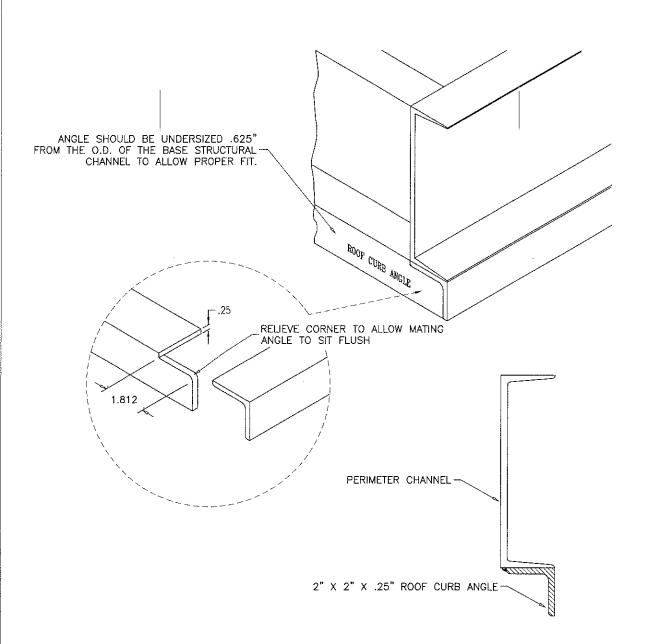

ROOF CURB ANGLE MOUNTING GUIDELINES AT BASE

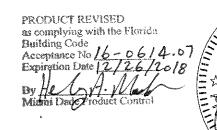

NOE THIS SHEET REE COMMENTS 1499 EAST PHILADELPHIA STREET VODI DA 17403
1 1 1 1 1 1 1 1 1 1 1 1 1 1 1 1 1 1 1

revisions:
no date
A 04.16.13
B 06.21.13
C 10.01.13
D 08.22.14
E 06.09.16

TARIQ

scale:

drawing no. 12-06 sheet 16 of 19

dr. by: chk. by:

(C.A.N. 3538) FAX. (305) 262-6978


815-4198


(717)

(717) 815-4218

TEL.

AL-FAROOQ CORPORATION
ENGINEERS & PRODUCT DEVELOPMENT
9360 SUNSET DRIVE, SUITE 220
MIAMI, FLORIDA 33173 (C.A.N. 3538)
TEL. (305) 264-8100 FAX. (305) 262-6978

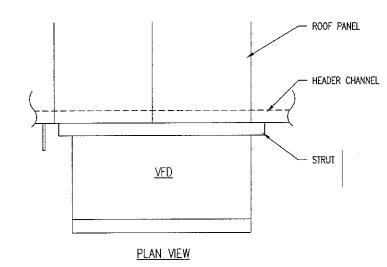

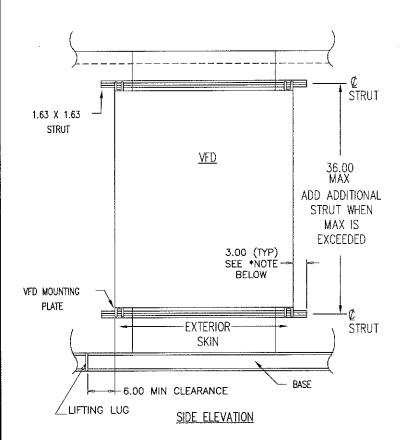


*OVERHANG TO BE MAINTAINED IF POSSIBLE ON NEMA 1 BOXES. *OVERHANG MUST BE MET OR EXCEEDED WHEN BOX IS NEMA 3R

DETAILING NOTES:


- . STRUTS FOR VFD'S WEIGHING MORE THAN 250lbs WILL BE MOUNTED WITH #12-16 TEK SCREW. DETERMINE FASTENER QTY PER STRUT USING THE FOLLOWING FORMULA: ROUND UP (WEIGHT OF PANEL DIVIDED BY 40), ADDITIONAL CHANNELS ADDED IN WALL PANEL BEHIND VFD'S.
- 2. STRUTS FOR VFD'S WEIGHING LESS THAN 250lbs WILL BE MOUNTED WITH #10-16 TEK SCREW. DETERMINE FASTENER QTY PER STRUT USING THE FOLLOWING FORMULA: ROUND UP (WEIGHT OF PANEL DIVIDED BY 30)

ASSEMBLY NOTES:

- 1. ELECTRIC DEPT. TO DRILL .313" DIAMETER HOLES IN THE UNISTRUT TO MATCH THE ABOVE SPACING FOR 250ibs AND OVER VFD'S.
- 2. CAULK PANEL SEAMS THAT WILL BE COVERED BY STRUT AND POWER PANEL.
- 3. ADD .13 X .75 GASKET TAPE TO BACK SIDE OF BOTH UPPER AND LOWER STRUTS, GASKET TAPE SHOULD BE CENTERED ON HOLE AND RUN THE FULL LENGTH OF THE STRUT.
- 4. FOR VFD'S 250lbs AND OVER, SCREW UPPER AND LOWER STRUTS TO WALL WITH #12-16 TEK SCREWS. FOR VFD UNDER 250lbs SCREW UPPER AND LOWER STRUT TO EXTERIOR USING #12-16 TEK SCREW.
- 5. DRILL TWO .4375 INCH DIAMETER HOLES FOR EACH PIECE OF STRUT IN THE BACK OF PANEL TO MATCH STRUTS LOCATIONS.
- 6. BOLT POWER PANEL/CONTROL PANEL TO STRUT USING .38 ELECTRIC SPRINGS NUTS AND .38 X 1.0 NC GRADE 2 HCS.
- 7. CAULKING STRUT IS NOT REQUIRED, BUT DRIVE SCREW HEADS SHOULD BE CAULKED ON OUTDOOR UNITS.

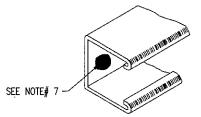

SURFACE MOUNT VFD MOUNTING DETAILS

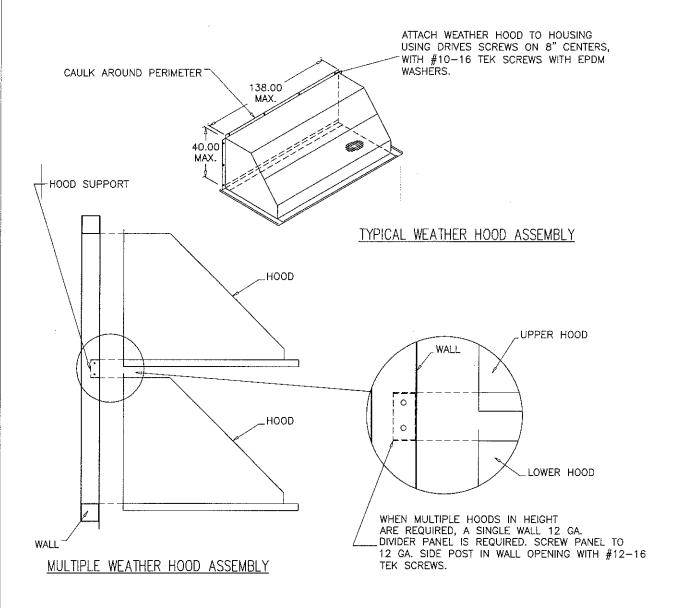

40" MAX. HOOD HEIGHT WHEN SINGLE HOOD IS USED LIMIT MAX. HEIGHT TO 20" WHEN MULTIPLE HOODS ARE USED.

SIZING GUIDELINES:

- 1. 60' WEATHER HOODS ARE AVAILABLE IN ANY HEIGHT FROM 12.00 INCHES TO 45.00 INCHES, ONLY BY SQ.
- 2. 90' WEATHER HOODS ARE AVAILABLE IN HEIGHTS UP TO 40".
- 3. WEATHER HOODS ARE AVAILABLE IN WHOLE NUMBER WIDTHS FROM 16.00 INCHES TO 138.00 INCHES.

MATERIAL:

1. STANDARD WEATHER HOOD MATERIAL IS 16GA PRE-PAINTED.

WEATHER HOOD SIZING & CONSTRUCTION GUIDELINES

PRODUCT REVISED as complying with the Florida **Building Code** Acceptance No 6 -Expiration Date 2

AL-FAROOQ CORPORATION

ENGINEERS & PRODUCT DEVELOPMENT

9360 SUNSET DRIVE, SUITE 220

MIAMI, FLORIDA 33.173 (C.A.N. 3538)

TEL. (305) 264.8100 FAX. (305) 262-6978

COOLER \ 12

Jii. YORK/JOHNSON CONTROLS INC. 1499 EAST PHILADELPHIA STREET YORK, PA. 17403 TEL. (717) 815–4218 FAX. (717) 815–419 Miller-Picking) Air Handler ઝ

description

NO CHANGE THIS SHEET

REV. PER RER COMMENTS

NO CHANGE THIS SHEET


NO CHANGE THIS SHEET


SERIES NAME REV. no date
A 04.16.13
B 06.21.13
C 10.01.13
D 08.22.14

中域で scale: 유 | 유


drawing no.

12 - 06sheet 17 of 19

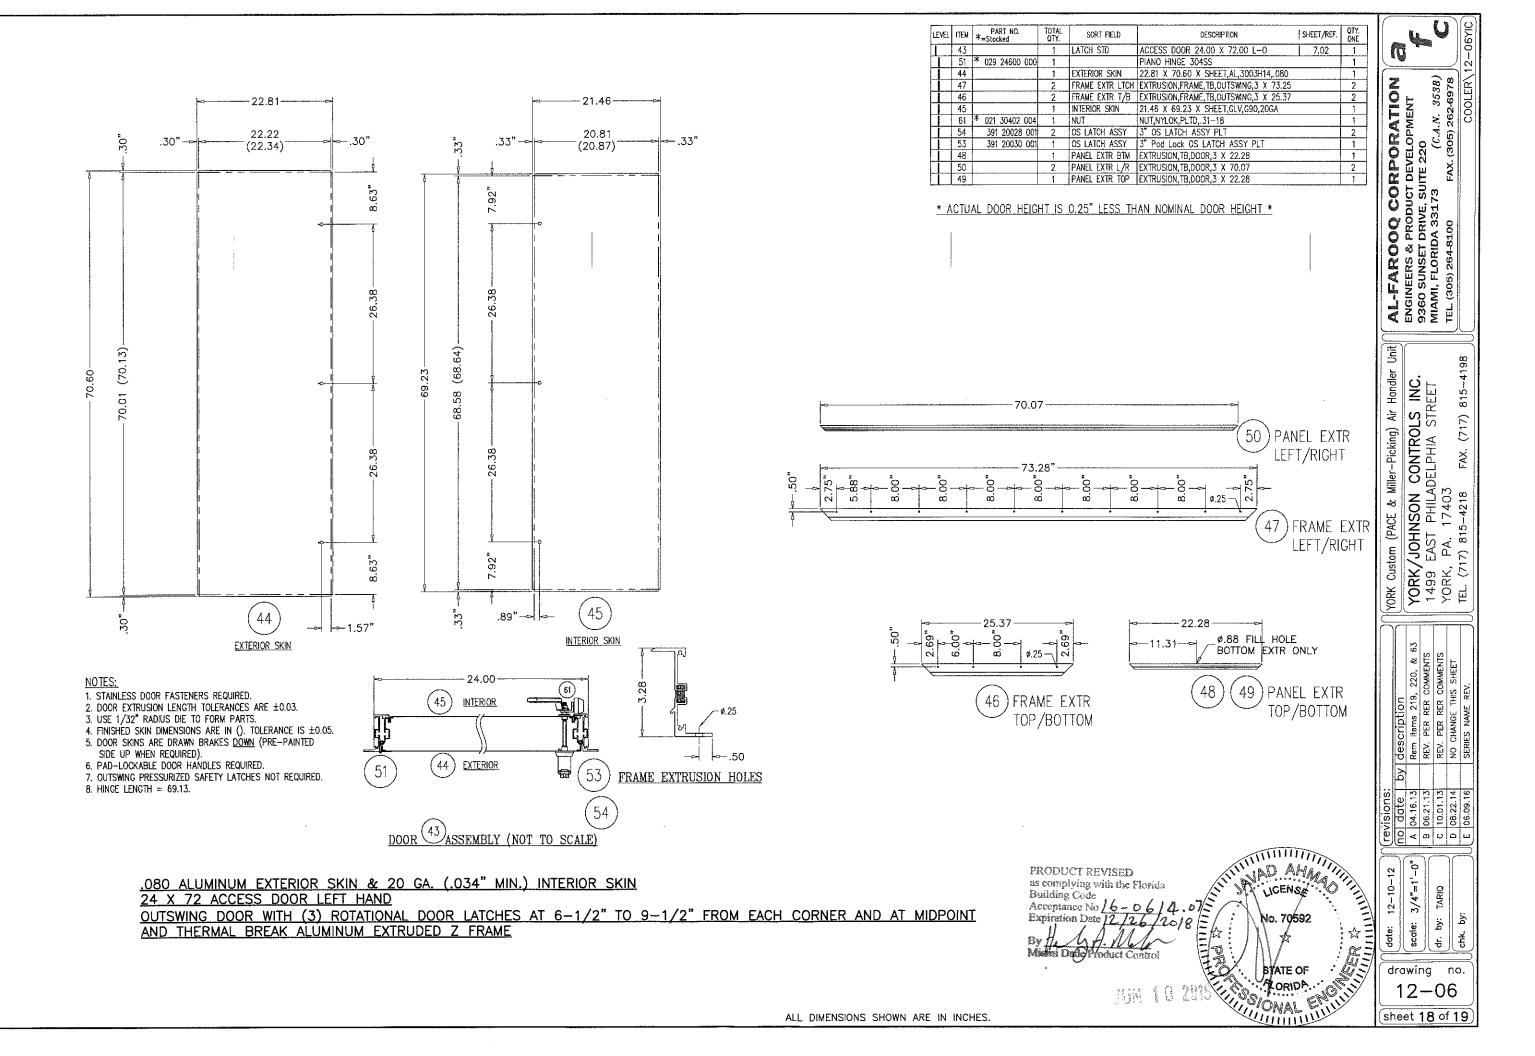


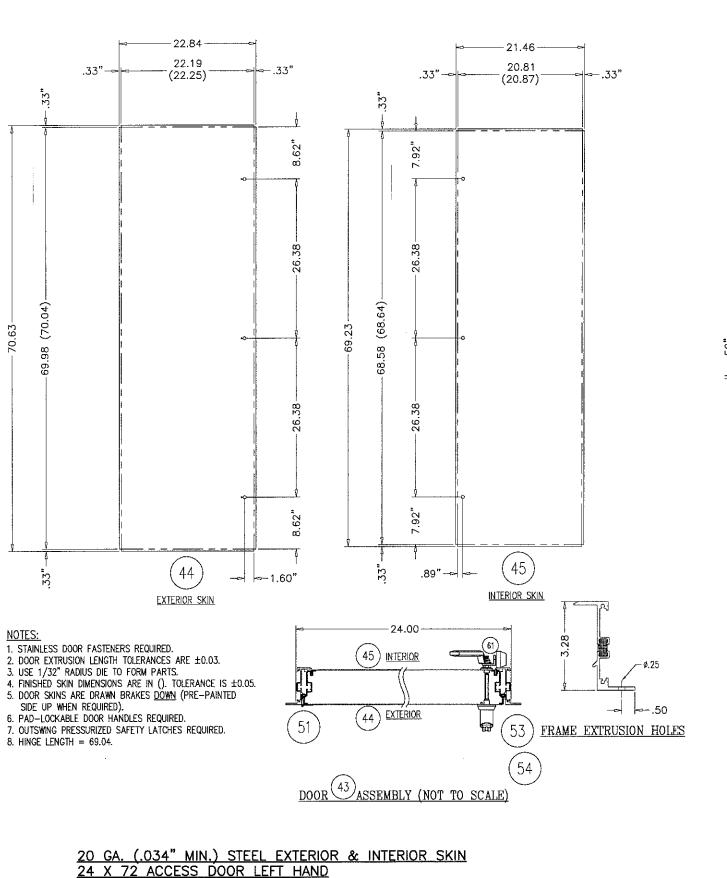


OUTSWING DOOR WITH (3) ROTATIONAL DOOR LATCHES AT 6-1/2" TO 9-1/2" FROM EACH CORNER AND AT MIDPOINT AND THERMAL BREAK ALUMINUM EXTRUDED Z FRAME

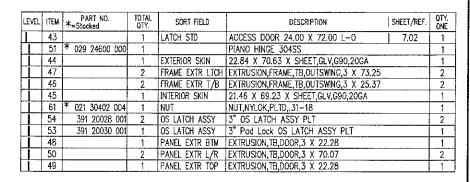

* ACTUAL DOOR HEIGHT IS 0.25" LESS THAN NOMINAL DOOR HEIGHT *

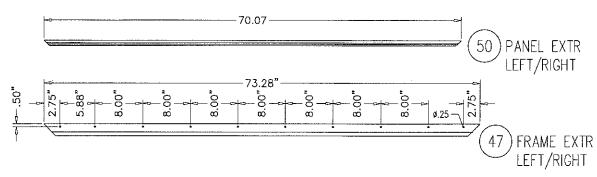

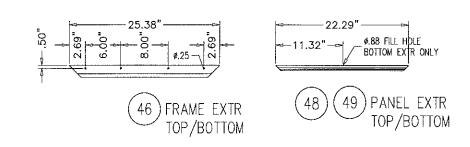

PRODUCT REVISED as complying with the Florida Building Code Acceptance No 16-0614.07 Expiration Date 12/26, By He S. A. M. W /2018

No. 70592

STATE OF

A ORIDA

ONAL ENTITION

YORK/JOHNSON CONTROLS INC.
1499 EAST PHILADELPHIA STREET
YORK, PA. 17403
TEL. (717) 815–4218 FAX. (717) 815 YORK Custom (PACE & Miller-Picking)

(C.A.N. 3538) FAX. (305) 262-6978

815-4198

AL-FAROOQ CORPORATION
ENGINEERS & PRODUCT DEVELOPMENT
9360 SUNSET DRIVE, SUITE 220
MIAMI, FLORIDA 33173 (C.A.N. 3538)
TEL. (305) 2648100 FAX. (305) 262-6978

Z TE

revisions:
no date
A 04.16.13
B 06.21.13
C 10.01.13
D 08.22.14
E 06.09.16 scale: 3/4"=1'-0" þ. ∦ ਜ਼ੈ ∦ ਲੋਂ

drawing no. 12-06

sheet 19 of 19

ALL DIMENSIONS SHOWN ARE IN INCHES.